

April 17, 2023

Ms. Jennifer Meyer  
Remediation and Redevelopment Program  
Wisconsin Department of Natural Resources  
1027 W. St. Paul Ave  
Milwaukee, WI 53233

**Project # 40443A**

**Subject: Revised Additional Vapor Mitigation System Commissioning Plan for  
Community Within the Corridor – West Block  
3212 W. Center St., 2727 N. 32nd St., and 2758 N. 33rd St., Milwaukee, WI 53210  
BRRTS #: 02-41-587376, FID #: 341333190**

Dear Ms. Meyer:

On behalf of the Community Within the Corridor Limited Partnership (CWC), K. Singh & Associates, Inc. (KSingh) proposes a Revised Additional Vapor Mitigation Commissioning plan for the west block property. KSingh requests that the WDNR review this response and grant approval to proceed with additional testing of the vapor mitigation system. A Technical Assistance Fee in the amount of \$700 is attached with this letter.

### **Project Background**

On February 17, 2023, KSingh submitted an Additional Vapor Mitigation System Commissioning Plan for the West Block based on previous commissioning performed in June 2022, September 2022, and December 2022 meeting or exceeding the VALs for Tetrachloroethylene (PCE) or Trichloroethylene (TCE) during one round of testing. During the three rounds of commissioning, four passive air sample locations exceeded their respective VALs in at least one round of commissioning. The VAL exceedances are summarized below.

- One sample, IA-8A-01B, exceeded the VAL for PCE of 42 ug/m<sup>3</sup> during the first round of commissioning in June 2022 and met the VAL for PCE on the subsequent two rounds of Commissioning.
- Three samples, IA-6-01A, IA-7-01A, and IA-8B-01B, exceeded the VAL of 2.1 ug/m<sup>3</sup> for TCE during the second round of commissioning in September 2022 and met the VAL during the December 2022 round of Commissioning.
- These four locations were proposed to be resampled until 3 consecutive rounds of sampling demonstrate compliance with VALs.

Based on the proposed Commissioning Plan, 4 indoor air samples were collected utilizing passive samplers at locations IA-6-01A, IA-7-01A, IA-8A-01B, and IA-8B-01B from February 8, 2023 to February 15, 2023 in conjunction with Commissioning Sampling for Buildings 4 and 5. Results of the February 2023 Additional

Commissioning sampling, which showed no reoccurrence of VAL exceedances, are summarized in Table 1.

### **WDNR Response**

On March 29, 2023, WDNR provided feedback on the proposed Additional Commissioning Plan. WDNR's feedback is included in Attachment A and summarized below, in italics, with our responses following.

1. *Per Wis. Admin. Code § NR 726.13(1)(b), the DNR may not close a case if the remaining level of contamination is likely to cause a VAL in indoor air to be attained or exceeded. Further, per Wis. Admin. Code § NR 722.09(2)(d), where a discharge of volatile hazardous substances has occurred, such as trichloroethylene (TCE), one of the contaminants of concern at the site, the vapor intrusion pathway shall be evaluated to determine the likelihood of those substances entering the breathing space of a structure. To demonstrate these administrative code requirements are met, all indoor air sample locations throughout Buildings 6, 7, 8A, and 8B (IA-6-01A to IA-8B-02D) should be re-sampled using passive samplers, as the previous commissioning rounds detected TCE just below the residential VAL at several sample locations.*

We acknowledge WDNR's concerns and will endeavor to address them during the next round of sampling. However, as TCE is heavier than air with a molecular weight of 131.39, and no TCE has ever been detected in the facility above ground level based on three previous rounds of testing, we therefore are proposing to modify the plan by proposing to perform no passive sampling on levels 2 and 3 of Buildings 6, 7, 8A, and 8B. To allay WDNR concerns, we are proposing to instead collect 19 discrete samples on Levels 2 and 3 and report the results based on portable gas chromatograph (GC) analysis.

2. *Per Wis. Admin. Code § NR 724.13(1)(d), all pressure field extension (PFE) points (SVP-1 to SVP-16) should be re-measured concurrently with the additional passive indoor air sampling. It appears that, over the first three rounds of commissioning, the PFE results have generally diminished in magnitude and are now approaching the minimum recommended differential negative pressure of 0.004 inches H<sub>2</sub>O.*

We will perform PFE testing as requested. We note that the PFE readings previously measured followed the expected seasonal variation with the lowest readings occurring during heating season. If PFE readings are measured not meeting the -0.004 inches of water depressurization standard, the fan capacity will be adjusted, turning up the speed on adjustable fans or upgrading the fan capacity with larger fans, as necessary.

3. *Concerning the VMS commissioning of Buildings 4 and 5, if there are any indoor air VAL exceedances identified in the first round, or any subsequent rounds of commissioning, there could be acute human health risks present in the site buildings. The proposed schedule for occupancy should consider these health risks and potential modifications that may be needed to the VMS and/or the site buildings prior to occupancy to help to ensure that the buildings are safe for occupants. Continue to keep the DNR updated in a timely manner on the occupancy schedule as development of these buildings progresses.*

One round of VMS commissioning of Buildings 4 and 5 has been completed and results submitted to WDNR. The results were all no detect for TCE in indoor air. No occupancy in buildings 4 and 5 has occurred as of the date of this letter. The second round is scheduled to commence during the week of April 23, 2023. The results and schedule for occupancy will be discussed following receipt of Commissioning test results.

4. *Concurrent commissioning information for all site buildings is necessary to understand site conditions. All future commissioning events should include all site buildings unless otherwise directed by the DNR.*

We have scheduled the proposed additional Commissioning to coincide with the second round of commissioning for Buildings 4 and 5. Any subsequent testing will also occur in conjunction with commissioning of Buildings 4 and 5.

#### **Additional Vapor Mitigation Commissioning Plan**

The following scope of work is proposed for additional commissioning.

- Work is scheduled for the week of April 23, 2023.
- One round of sub-slab vacuum measurements will be performed at locations SVP-1 to SVP-16 on the ground floor of buildings 6, 7, 8A, and 8B. The locations of the proposed measurements are included on Figure 1.
- One round of passive air sampling at locations is proposed for April 2023. The passive sample locations include OA-6/7/8A/8B-Background, IA-6-Basement, IA-8A-Basement, IA-6-01A, IA-6-01B, IA-6-01C, IA-7-01A, IA-7-01B, IA-7-01C, IA-7-01D, IA-8A-01A, IA-8A-01B, IA-8A-01C, IA-8A-01D, IA-8B-01A, IA-8B-01B, IA-8B-01C, and IA-8B-01D for a total of 15 locations on the ground floor and in the basement of buildings 6, 7, 8A, and 8B. The locations of the proposed samples are shown in Attachment B.
- Portable GC test locations are proposed for IA-06-02A, IA-06-02B, IA-06-02C, IA-7-02A, IA-7-02B, IA-7-02C, IA-8A-02A, IA-8A-02B, IA-8A-02C, IA-8A-02D, IA-8B-02A, IA-8B-02B, IA-8B-02C, IA-8B-02D, IA-8A-03A, IA-8A-03B, IA-8A-03C, IA-8A-03D, IA-8A-03E, and IA-8A-03F. 19 portable GC discrete samples are proposed in total on the 2<sup>nd</sup> and 3<sup>rd</sup> floors of buildings 6, 7, 8A, and 8B. Discrete sample results will be provided to WDNR within 10 days of collection and additional samples will be collected at WDNR request. The locations of the proposed samples are included in Attachment B.

Following completion of the April additional commissioning sampling, a report documenting findings will be submitted to WDNR in May 2023 within 10 days of receiving test results.


We request WDNR's approval of this revised Additional Commissioning Plan. As we prefer to perform this work in conjunction with the second round of Commissioning of Building 4 and 5, as requested, we are proposing to proceed with our proposed plan unless WDNR says otherwise. Please contact us if you have any questions or seek clarification regarding this submittal.

Sincerely,

K. SINGH & ASSOCIATES, INC.



Robert T. Reineke, P.E.  
Project Manager

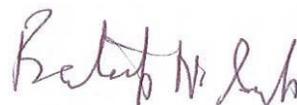

Pratap N. Singh, Ph.D., P.E.  
Principal Engineer



cc: Que El-Amin / Scott Crawford, Inc.  
Shane LaFave / Roers Companies

Attachments:

Figure 1 Subslab Depressurization Measurement Locations  
Table 1 Results of Passive Air Sampling


Attachment A WDNR Correspondence  
Attachment B Air Sampling Locations  
Attachment C PE Certification

FIGURE

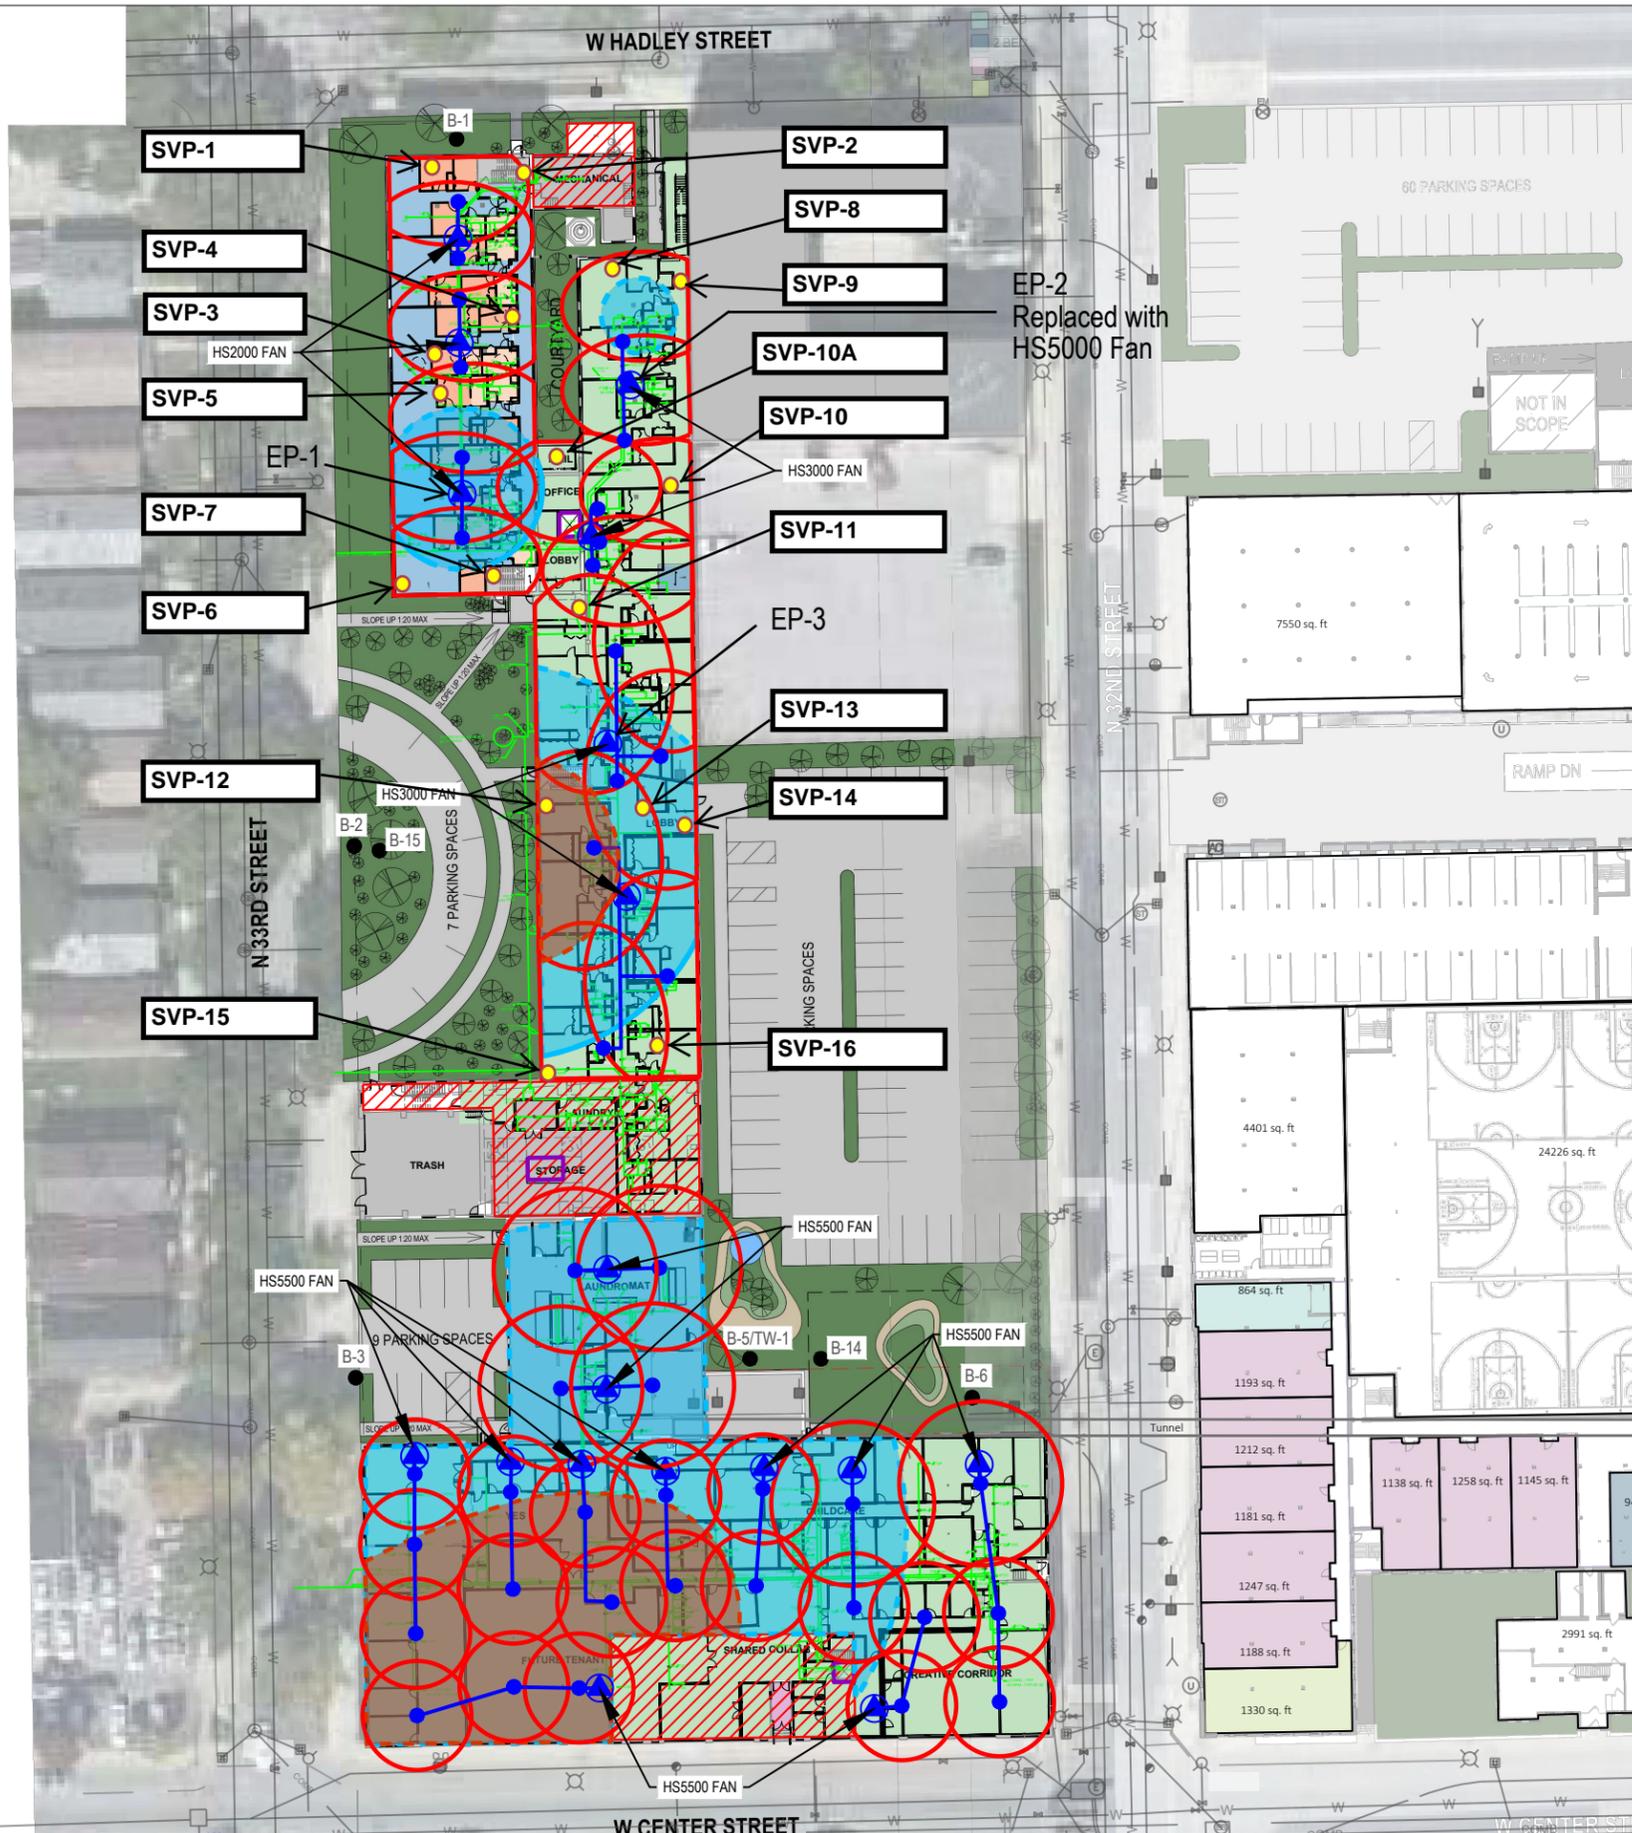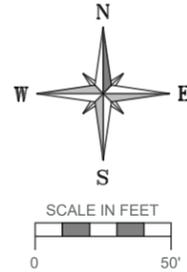

**LEGEND**

- Previous Boring and Temporary Well Locations
- Known Elevator Shaft
- Planned Underground Plumbing
- ▭ Underground Tunnel
- ▨ Basement Area(s)
- Extraction Point Location
- 3" sch. 40 PVC pipe (may be modified)
- ⊙ Exterior Fan Location
- Zone of Influence
- ⊞ Approximate WI Residential VRSL Exceedance Extents
- ⊞ Approximate WI Small Commercial VRSL Exceedance Extents
- Sub-slab Vapor Pin (SVP-xx)

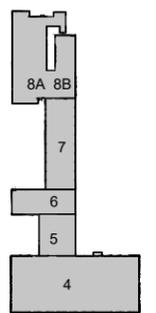

**KEY PLAN**

**NOTES:**

1. MINIMUM OF 3.5" SLAB PENETRATION
2. 10-15 "GALL" SOIL REMOVED BENEATH SLAB TO ACT AS SUCTION PIT
3. SEE TABLE FOR RADII FOOTAGE
4. 3" SCH. 40 PVC
5. BALL VALVES FOR EACH EXTRACTION POINT TO REGULATE FLOW
6. MANOMETER AND VELOCITY PORTS FOR EACH EXTRACTION POINT TO MEASURE FLOW AND NEGATIVE PRESSURE
7. MANOMETER POINT AT EACH FAN INLET FOR NEGATIVE PRESSURE
8. EXHAUST VENTING 2 FT ABOVE ROOF AND/OR 12 FT FROM WINDOWS
9. MIN 1.5% SLOPE TOWARD EXTRACTION POINTS
10. ELECTRICAL DISCONNECT AND OWN CIRCUIT FOR EACH FAN
11. 2" EXHAUST PIPING FOR HS FANS, 3" FOR GP501C
12. SEAL ALL CRACKS IN FLOORS
13. PLANS UNDERWAY TO REVISE WD-SV TO SC-1 UNDERLAIN BY 50-MIL SUB-MEMBRANE.

**PROJECT TITLE:** SITE INVESTIGATION REPORT  
3212 W. CENTER ST., 2727 N. 32ND ST., 2758 N. 33RD ST.  
COMMUNITY WITHIN THE CORRIDOR - WEST BLOCK  
MILWAUKEE, WI 53210  
PROJECT NUMBER: 40443

**CLIENT:** COMMUNITY WITHIN THE CORRIDOR LIMITED PARTNERSHIP

REVISIONS	DATE	DESCRIPTION

DRAWN BY: JPB DATE: 06/02/2022  
CHECKED BY: RTR DATE: 06/02/2022

**FIGURE 1**

SHEET 6 of SHEET 6

ATTACHMENT A  
WDNR Correspondence



March 29, 2023

Mr. Shane LaFave  
Roers Companies  
110 Cheshire Lane, Suite 120  
Minnetonka, MN 55305  
*Via Email Only* [shane@roerscompanies.com](mailto:shane@roerscompanies.com)

Subject: Technical Assistance Provided – Review of Additional Commissioning Plan  
Community Within the Corridor – West Block  
3212 W. Center Street, 2727 N. 32nd Street, & 2758 N. 33rd Street, Milwaukee, WI  
BRRTS #02-41-587376, FID #341333190

Dear Mr. LaFave:

On March 2, 2023, the Wisconsin Department of Natural Resources (DNR) received *Proposed Additional Vapor Mitigation System Commissioning Plan* (the Report), dated February 17, 2023, prepared by K. Singh and Associates, Inc. (K. Singh) on behalf of Community Within the Corridor, Limited Partnership, for the site identified above. The Report was submitted with a technical assistance request fee of \$700 for DNR review and written response. The DNR reviewed the Report for regulatory compliance with Wisconsin Administrative (Wis. Admin.) Code series NR 700, and has determined that the commissioning plan, as presented in the Report, cannot be approved at this time.

#### Report Summary

The Report presented the following plan for additional vapor mitigation system (VMS) commissioning for Buildings 6, 7, 8A, and 8B at the site, which assumes that the results from the proposed indoor air sampling outlined below are less than the applicable residential vapor action levels (VALs):

1. Perform passive indoor air sampling in February 2023 at sample locations where residential VAL exceedances were identified during the second commissioning round (IA-8A-01B, IA-6-01A, IA-7-01A, and IA-8B-01B).
2. Submit the above sample results to the DNR in March 2023.
3. Perform passive indoor air sampling at sample locations IA-6-01A, IA-7-01A, and IA-8B-01B in May 2023.
4. Submit a report to the DNR in June 2023 that documents the commissioning findings.

On March 8, 2023, K. Singh informed the DNR during a phone call that step one sampling has already been completed and that the next commissioning round will likely occur in April 2023 instead of May 2023. K. Singh informed the DNR in the March 8, 2023, phone call that there were no VAL exceedances identified during step one sampling. The DNR has not yet received the sample results collected during step one sampling. Furthermore, during the March 8, 2023, phone call, K. Singh indicated that the first round of commissioning for Buildings 4 and 5 at the site was completed in January/February 2023 and that occupancy for these buildings is scheduled for April/May 2023. It is the DNR's understanding that Buildings 4 and 5 will primarily be used for commercial purposes, aside from the day care center in Building 4 which is considered a residential setting, per Wis. Admin

Code NR § 700.03(49g). The DNR has not yet received the sample results for the first round of commissioning for Buildings 4 and 5.

### Report Review

The DNR provides the following feedback for the commissioning plan:

1. Per Wis. Admin. Code § NR 726.13(1)(b), the DNR may not close a case if the remaining level of contamination is likely to cause a VAL in indoor air to be attained or exceeded. Further, per Wis. Admin. Code § NR 722.09(2)(d), where a discharge of volatile hazardous substances has occurred, such as trichloroethylene (TCE), one of the contaminants of concern at the site, the vapor intrusion pathway shall be evaluated to determine the likelihood of those substances entering the breathing space of a structure. To demonstrate these administrative code requirements are met, all indoor air sample locations throughout Buildings 6, 7, 8A, and 8B (IA-6-01A to IA-8B-02D) should be re-sampled using passive samplers, as the previous commissioning rounds detected TCE just below the residential VAL at several sample locations.
2. Per Wis. Admin. Code § NR 724.13(1)(d), all pressure field extension (PFE) points (SVP-1 to SVP-16) should be re-measured concurrently with the additional passive indoor air sampling. It appears that, over the first three rounds of commissioning, the PFE results have generally diminished in magnitude and are now approaching the minimum recommended differential negative pressure of 0.004 inches H<sub>2</sub>O.
3. Concerning the VMS commissioning of Buildings 4 and 5, if there are any indoor air VAL exceedances identified in the first round, or any subsequent rounds of commissioning, there could be acute human health risks present in the site buildings. The proposed schedule for occupancy should consider these health risks and potential modifications that may be needed to the VMS and/or the site buildings prior to occupancy to help to ensure that the buildings are safe for occupants. Continue to keep the DNR updated in a timely manner on the occupancy schedule as development of these buildings progresses.
4. Concurrent commissioning information for all site buildings is necessary to understand site conditions. All future commissioning events should include all site buildings unless otherwise directed by the DNR.

### Next Steps

In consideration of administrative code requirements, the DNR is requesting the implementation of the following schedule:

- The DNR recommends that the feedback provided in this letter be implemented into the commissioning round scheduled for April 2023.
- Per Wis. Admin. Code § NR 716.14, submit all sampling results within 10 days (on appropriately formatted tables) of receiving laboratory data. Immediate notification of results upon receipt is justified under Wis. Admin. Code §§ NR 708.05 and 714.07 when the building is occupied and there is exposure to an acute (immediate) health risk (e.g., TCE is present above the VAL and women of child-bearing age are present).

The DNR appreciates the actions you are taking to restore the environment at this site. If you have any questions concerning the site or this letter, please contact me at (414) 435-8021, or by email at

[jane.pfeiffer@wisconsin.gov](mailto:jane.pfeiffer@wisconsin.gov).

Sincerely,



Jane K. Pfeiffer  
Project Manager – Hydrogeologist  
Remediation & Redevelopment Program


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BRRTS #02-41-587376

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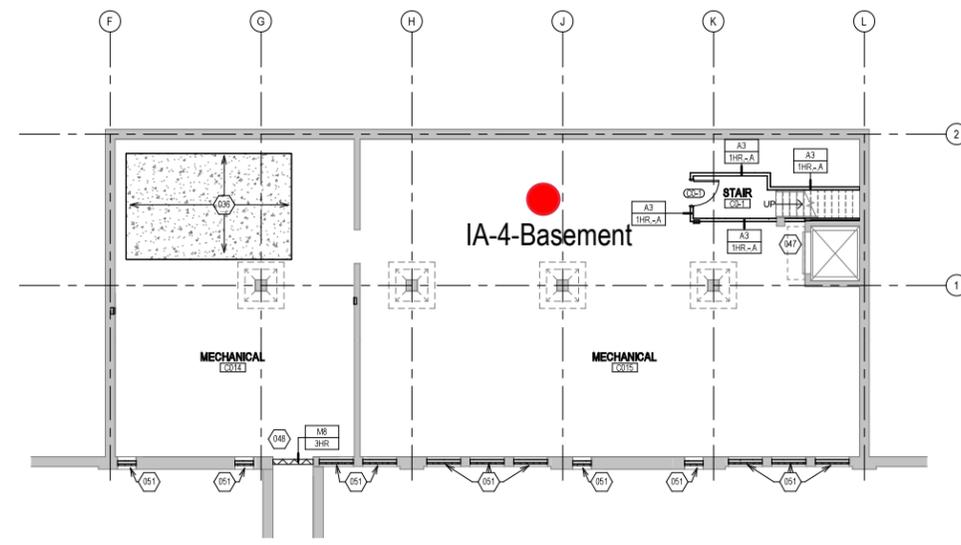
cc: Mr. Que El-Amin, Scott Crawford, Inc. – [que@scott-crawford.com](mailto:que@scott-crawford.com)  
Mr. Robert Reineke, K. Singh & Associates, Inc. – [reineke@ksinghengineering.com](mailto:reineke@ksinghengineering.com)  
Dr. Pratap N. Singh, K Singh & Associates, Inc. – [psingh@ksinghengineering.com](mailto:psingh@ksinghengineering.com)

ATTACHMENT B

Air Sampling Locations

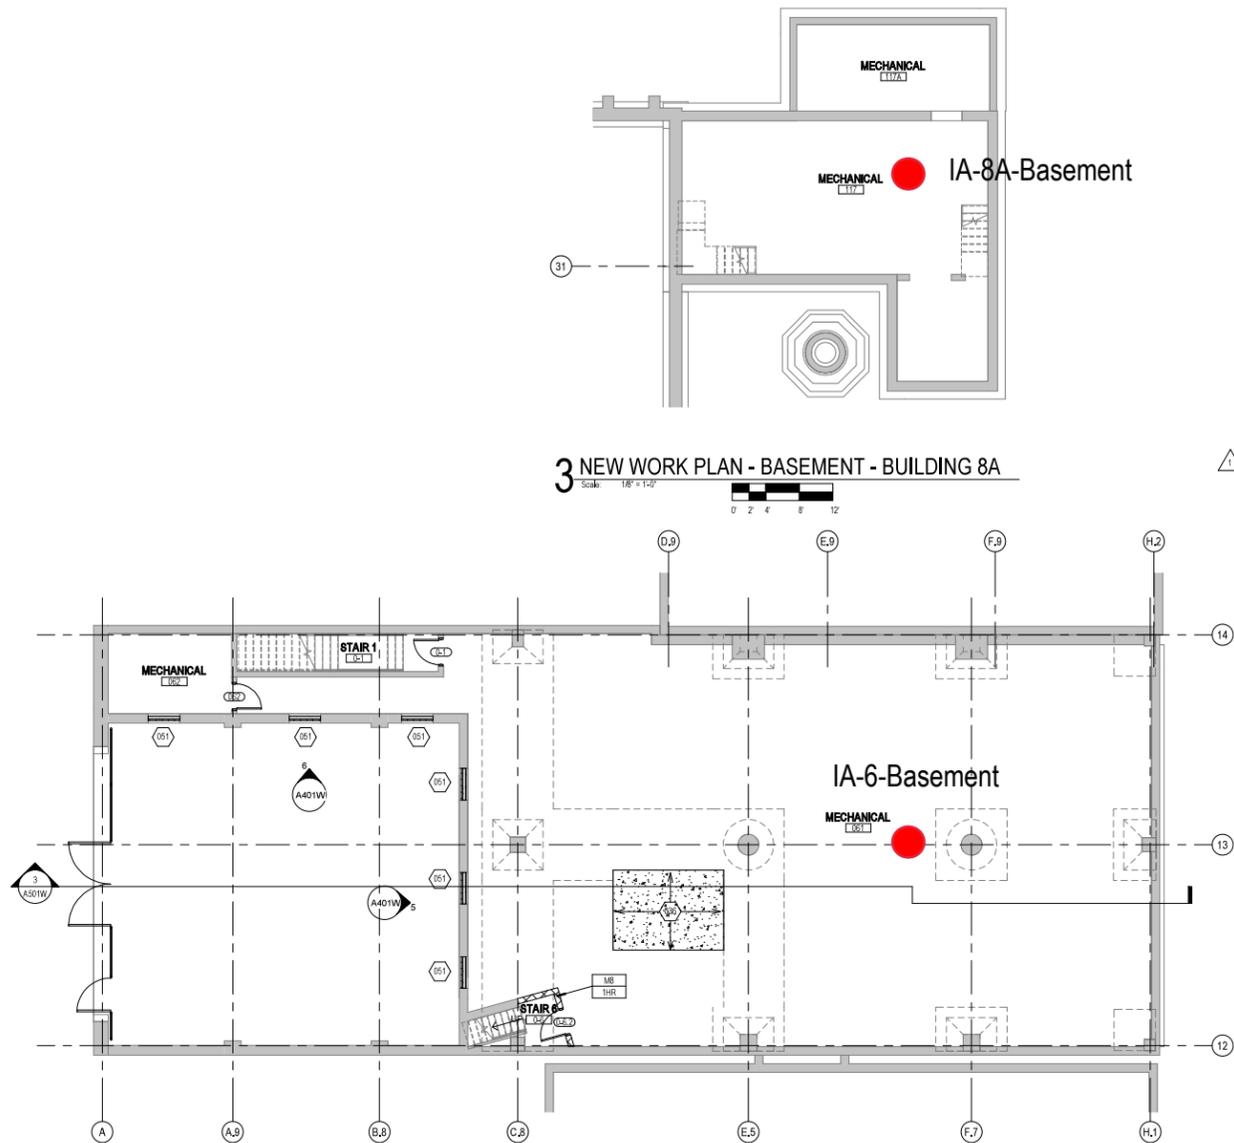

2 NEW WORK PLAN - BASEMENT - BUILDING 6  
Scale: 1/8" = 1'-0"



1 NEW WORK PLAN - BASEMENT - BUILDING 4  
Scale: 1/8" = 1'-0"

**NEW WORK PLAN KEY NOTES - 1/8" PLANS**

SEE PROJECT GENERAL CONDITIONS, GENERAL INFORMATION ON SHEET A001W AND SELECTIVE DEMOLITION, CUTTING AND PATCHING SPECIFICATIONS THAT ARE USED IN ASSOCIATION WITH THESE NOTES.

NEW WORK PLAN KEY NOTES APPLY TO ALL 1/8" NEW WORK DRAWINGS AND MAY NOT BE USED ON EVERY SHEET.

- SEE UNIT 137 ENLARGED PLAN.
- SEE UNIT 105 ENLARGED PLAN.
- SEE UNIT 113 ENLARGED PLAN.
- SEE UNIT 18 ENLARGED PLAN. UNIT MAY BE MIRRORRED.
- SEE UNIT 149 ENLARGED PLAN.
- SEE UNIT 131 ENLARGED PLAN.
- SEE UNIT 132 ENLARGED PLAN.
- SEE UNIT 202 ENLARGED PLAN.
- SEE UNIT 251 ENLARGED PLAN.
- SEE UNIT 146 ENLARGED PLAN.
- SEE UNIT 151 ENLARGED PLAN.
- SEE UNIT 152 ENLARGED PLAN.
- SEE UNIT 203 ENLARGED PLAN.
- SEE UNIT 242 ENLARGED PLAN.
- SEE UNIT 128 ENLARGED PLAN. UNIT MAY BE MIRRORRED.
- SEE UNIT 223 ENLARGED PLAN.
- SEE UNIT 201 ENLARGED PLAN.
- SEE UNIT 111 ENLARGED PLAN.
- SEE UNIT 217 ENLARGED PLAN.
- SEE UNIT 124 ENLARGED PLAN.
- SEE UNIT 224 ENLARGED PLAN.
- SEE UNIT 223 ENLARGED PLAN.
- SEE UNIT 189 ENLARGED PLAN.
- SEE UNIT 115 ENLARGED PLAN.
- SEE UNIT 130 ENLARGED PLAN. UNIT MAY BE MIRRORRED.
- SEE UNIT 215 ENLARGED PLAN.
- SEE UNIT 205 ENLARGED PLAN.
- SEE UNIT 314 ENLARGED PLAN.
- SEE UNIT 139 ENLARGED PLAN.
- SEE UNIT 140 ENLARGED PLAN.
- SEE UNIT 207 ENLARGED PLAN.
- SEE UNIT 213 ENLARGED PLAN. UNIT TO INCLUDE AUDIO AND VISUAL ALARM DEVICES FOR THE HEARING AND VISUALLY IMPAIRED. COORDINATE LOCATION WITH ELECTRICAL DRAWINGS.
- SEE UNIT 147 ENLARGED PLAN.
- SEE UNIT 172 ENLARGED PLAN.
- SEE UNIT 206 ENLARGED PLAN.
- NEW CONCRETE ON METAL DECK INFILL WITH SPRAY-APPLIED FIRE RESISTIVE MATERIAL AT NEW STEEL BEAMS AND ANGLES TO MAINTAIN FLOOR ASSEMBLY FIRE RATING. SEE OVERVIEW FLOOR PLANS FOR REQUIRED FLOOR ASSEMBLY FIRE RATINGS. SEE STRUCTURAL FOR DETAIL.
- NEW CONCRETE INFILL AT EXISTING PT. ON ADJACENT FLOOR LEVEL FINISH AND TEXTURE.
- PATCH AND REPAIR DAMAGED CONCRETE SLAB TO MATCH ADJACENT FLOOR LEVEL, FINISH AND SURFACE TEXTURE.
- NEW TIMBER FLOOR DECK INFILL TO MATCH EXISTING. SEE STRUCTURAL.
- NEW CONCRETE INFILL SLAB AT EXISTING SUNKEN STAIR PIT. MATCH ADJACENT FLOOR LEVEL, FINISH AND SURFACE TEXTURE.
- PATCH & REPAIR CONCRETE SLAB WHERE EMBEDDED METAL PLATES AND/OR METAL TRENCH COVERS WERE REMOVED. FILL AND LEVEL WITH NEW CONCRETE TO MATCH ADJACENT SURFACE LEVEL AND FINISH TEXTURE. FEATHER CONCRETE TO LEVEL AT EXISTING METAL FLOOR OPENING FRAMES IF PRESENT.
- NEW INFILL WALL & PRECAST SILL TO REBUILD WINDOW OPENING. SEE ELEVATIONS. TOOTH IN SALVAGED BRICK WITH NEW MORTAR TO MATCH ADJACENT HISTORIC MASONRY.
- NEW INFILL WALL TO REBUILD WINDOW & DOOR OPENING. TOOTH IN SALVAGED MASONRY WITH NEW MORTAR TO MATCH ADJACENT HISTORIC MASONRY. PARSE SURFACES TO MATCH ADJACENT HISTORIC PARSE IF PRESENT.
- NEW PARTING INFILL WALL ASSEMBLY TO REBUILD OPENING IN EXISTING WALL BELOW SILL AT FLOOR LEVEL. SEE ELEVATIONS. TOOTH IN SALVAGED BRICK WITH NEW MORTAR TO MATCH ADJACENT HISTORIC MASONRY. SEE DETAIL 71AS10W FOR WALL ASSEMBLY.
- PATCH & REPAIR DAMAGED WALL OPENING AT SILL. TOOTH IN SALVAGED BRICK WITH NEW MORTAR AND PROVIDE NEW SILL TO MATCH ADJACENT HISTORIC MASONRY.
- PATCH & REPAIR DAMAGED AND MISSING PLASTER RETURNS AT JAMB, HEAD AND SILL TO MATCH EXISTING RETURNS. SEE WINDOW DETAILS. AT THESE WALLS THERE WILL BE A FURRING WITH 3/8" OSB EXTENDING FROM FLOOR TO TOP OF WALL AT UNDERSIDE OF STRUCTURE.
- PATCH & REPAIR DAMAGED AND MISSING PLASTER WOOD LATH FURRING WALL. PATCH AND REPAIR EXISTING RADUSED PLASTER RETURN PROFILES IF DAMAGED AT JAMB, HEAD AND SILL TO MATCH EXISTING RETURNS AT ADJACENT WINDOWS OF THE SAME TYPE.
- NEW GYPSUM BOARD INFILL WALL ASSEMBLY AT EXISTING OPENING. SEE DETAIL 11A10W.
- NEW CMU INFILL WALL ASSEMBLY AT EXISTING OPENING. SEE DETAIL 2A10W.
- NEW GYPSUM BOARD INFILL WALL ASSEMBLY AT EXISTING NON-HISTORIC WALL OPENING. MATCH EXISTING WALL ASSEMBLY WIDTH AND ADJACENT SURFACE FINISH.
- NEW METAL PANEL INFILL WALL ASSEMBLY AT EXISTING EXTERIOR MASONRY WALL OPENING. SEE DETAIL 5AS10W.

**NEW WORK PLAN KEY NOTES - 1/8" PLANS**

SEE PROJECT GENERAL CONDITIONS, GENERAL INFORMATION ON SHEET A001W AND SELECTIVE DEMOLITION, CUTTING AND PATCHING SPECIFICATIONS THAT ARE USED IN ASSOCIATION WITH THESE NOTES.

NEW WORK PLAN KEY NOTES APPLY TO ALL 1/8" NEW WORK DRAWINGS AND MAY NOT BE USED ON EVERY SHEET.

- NEW METAL PANEL INFILL WALL ASSEMBLY AT EXISTING WINDOW OPENING. SEE DETAIL 5A10W.
- EXISTING HISTORIC SLIDING FIRE DOOR ASSEMBLY TO REMAIN. SECURE SLIDING DOOR IN A FULLY OPEN POSITION WITH METAL Z-BRACKETS. PREPARE ENTIRE ASSEMBLY FOR PAINTED FINISH.
- EXISTING HISTORIC SLIDING FIRE DOOR ASSEMBLY TO REMAIN. SECURE SLIDING DOOR IN A CLOSED POSITION WITH METAL Z-BRACKETS. PREPARE ENTIRE ASSEMBLY FOR NEW PAINTED FINISH.
- REINSTALL SALVAGED HISTORIC SLIDING FIRE DOOR ASSEMBLY AND HARDWARE FROM THIS OPENING TO NEW ORIENTATION AS SHOWN. SECURE SLIDING DOOR IN A CLOSED POSITION WITH METAL Z-BRACKETS. PREPARE ENTIRE ASSEMBLY FOR NEW PAINTED FINISH.
- EXISTING HISTORIC COILING OVERHEAD DOOR ASSEMBLY TO REMAIN. SECURE COILING DOOR IN A FULLY OPEN POSITION. PREPARE ENTIRE ASSEMBLY FOR PAINTED FINISH.
- EXISTING HISTORIC COILING OVERHEAD DOOR ASSEMBLY TO REMAIN. SECURE COILING DOOR IN A FULLY CLOSED POSITION. PREPARE ENTIRE ASSEMBLY FOR PAINTED FINISH.
- EXISTING HISTORIC OVERHEAD DOOR ASSEMBLY TO REMAIN. REPAIR TRACK AND HARDWARE TO RETURN DOOR TO OPERATING CONDITION. PREPARE ENTIRE ASSEMBLY FOR PAINTED FINISH.
- EXISTING STEEL SASH WINDOW ASSEMBLY TO REMAIN. PREPARE ENTIRE ASSEMBLY FOR PAINTED FINISH. REPLACE BROKEN OR MISSING PANE OF GLASS WITH NEW GLASS TO MATCH EXISTING.
- NEW OPENING IN EXISTING CMU WALL. TOOTH IN NEW CMU AND MORTAR TO MATCH EXISTING.
- EXISTING GLAZED WALL TILE TO REMAIN. PROTECT DURING CONSTRUCTION.
- TUOPOINT AND REPAIR EXISTING CHIMNEY TO MATCH EXISTING MATERIALS. SEE EXTERIOR MASONRY REPORT AND DRAWINGS.
- EXISTING WOOD SINGLE HUNG WINDOW FRAME, SASH AND ALL CASING TRIM TO REMAIN. PREPARE EXISTING INTERIOR & EXTERIOR SURFACES FOR NEW PAINT. REPLACE MISSING AND/OR BROKEN GLASS TO MATCH EXISTING AND INSTALL NEW GLAZING PUTTY AT ALL PANEES. INSTALL NEW INTERIOR STORM WINDOWS. SEE DETAIL 13AS10W.
- ALIGN EDGE OF DEMISING WALL WITH EDGE OF HISTORIC MASONRY OPENING.
- ALIGN CENTER OF DEMISING WALL OR PARTITION WITH CENTERLINE OF HISTORIC COLUMN, OR BEAM ABOVE.
- ALIGN EDGE OF DEMISING WALL WITH EDGE OF HISTORIC CONCRETE DROP SLAB.
- ALIGN CENTER OF DEMISING WALL PARTITION WITH CENTERLINE OF WINDOW MULLION.
- ALIGN EDGE OF DEMISING WALL WITH OUTER EDGE OF LIGHT MONITOR MULLION.
- ALIGN CENTER OF DEMISING WALL OR PARTITION WITH CENTER OF HISTORIC SKYLIGHT MULLION ABOVE.
- NEW 3'X3 ACCESS DOOR W/ 3-HR RATING @ WALL TO ABANDONED MECHANICAL TUNNEL.
- NEW CONCRETE SLAB AT EXISTING STOOP TO MATCH FLOOR HEIGHT AT BUILDING 7. SEE STRUCTURAL.
- EXISTING WOOD STAIR GUARD AND HANDRAILS TO REMAIN. PREP ALL SURFACES FOR NEW PAINT.
- EXISTING WOOD STAIR GUARD AND HANDRAIL TO REMAIN. REPAIR/REPLACE MISSING BEAD BOARD HANDRAIL SUPPORT AND STAIR RUN FROM LEVEL 01 TO 1ST LANDING TO MATCH EXISTING HISTORIC CONDITION PERCENT. PROVIDE NEW STEEL HANDRAILS AT EXISTING CMU WALLS. PREP ALL SURFACES FOR NEW PAINT.
- EXISTING CONCRETE STAIR, CMU GUARD WALL AND HANDRAIL TO REMAIN. PREP ALL SURFACES FOR NEW FINISHES.
- PROVIDE NEW EGRESS BARRIER GATE AT EXISTING STEEL GUARDRAIL. EXISTING CONCRETE STAIR, STEEL GUARDRAIL AND HANDRAIL TO REMAIN. PREP ALL SURFACES FOR NEW FINISHES.
- NEW CHAINLINK FENCE & GATES AND FRAMING SLATS.
- BUILD TYPE PS UNIT DEMISING WALL WITH RESILIENT CHANNEL ON THIS SIDE.
- TAPER CONCRETE TOPPING 1.25" THICK MAX TO MEET EXISTING FINISH LEVEL AT TRANSITION AREA TO STAIRS OR BETWEEN BUILDINGS.
- NEW TAPERED POLISHED EPOXY FLOOR TOPPING TO TRANSITION FLOOR FINISH LEVEL CHANGE BETWEEN BUILDINGS 6 & 7.
- PATCH AND REPAIR DAMAGED AND MISSING EXTERIOR STUCCO TO MATCH ADJACENT SURFACE.

**GENERAL FLOOR PLAN NOTES TO CONTRACTOR**

- THIS DRAWING IS FURTHER SUPPORTED BY INFORMATION CONTAINED IN THE SPECIFICATION MANUAL.
- THE CIVIL, STRUCTURAL, MECHANICAL, ELECTRICAL, PLUMBING, FIRE PROTECTION, AUDIO-VISUAL, AND SECURITY DRAWINGS ARE SUPPLEMENTARY TO THE ARCHITECTURAL DRAWINGS. IT SHALL BE THE RESPONSIBILITY OF THE CONTRACTOR TO COORDINATE THE INFORMATION CONTAINED IN ALL THE DRAWINGS BEFORE THE INSTALLATION OF ALL WORK.
- DO NOT SCALE DRAWINGS. CONTRACTOR TO VERIFY ALL CONDITIONS AND DIMENSIONS AT THE JOB SITE PRIOR TO COMMENCING CONSTRUCTION.
- FLOOR ELEVATIONS ARE TO THE TOP OF THE SUB-FLOOR MATERIAL UNLESS OTHERWISE NOTED.
- CONTRACTORS SHALL JOINTLY PROVIDE AND INSTALL ALL STIFFENERS, BRACING, BACKING PLATES, WALL BLOCKING AND SUPPORTING BRACKETS REQUIRED FOR THE INSTALLATION OF CASEWORK, TOILET ACCESSORIES, PARTITIONS, MILLWORK, AND ALL WORK MOUNTED OR SUSPENDED BY ALL TRADES.

**NEW WORK PLAN LEGEND**

	EXISTING TO REMAIN		UN.L.O.
	MASONRY PARTITION. SEE PARTITION TYPES FOR DETAILS		UN.L.O.
	METAL STUD PARTITION. SEE PARTITION TYPES FOR DETAILS TYPE		UN.L.O.
	METAL STUD PARTITION. SEE PARTITION TYPES FOR DETAILS TYPE		UN.L.O.
	NEW WORK KEY NOTE		

**PATCH AND INFILL LEGEND**

	CONCRETE FLOOR OPENING INFILL. SEE STRUCTURAL FOR INFILL CONDITIONS. V.I.F. EXACT SIZE AND LOCATIONS.
	CONCRETE FLOOR COSMETIC PATCH. V.I.F. EXACT SIZE AND LOCATIONS.
	WOOD FLOOR STRUCTURAL INFILL. SEE STRUCTURAL FOR INFILL CONDITIONS. V.I.F. EXACT SIZE AND LOCATIONS.

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COMMUNITY WITHIN THE CORRIDOR - WEST BLOCK

2758 N. 38RD STREET  
MILWAUKEE, WI 53210

SHEET TITLE: NEW WORK PLAN - BASEMENT - BUILDINGS 4, 6 & 8A

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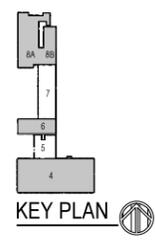
REVISIONS


1	10/09/20	ADDENDUM #1
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SCALE	VARIABLES
PROJECT NUMBER	200102
SET TYPE	CONSTRUCTION DOCUMENTS
DATE ISSUED	9/25/20
SHEET NUMBER	A201W

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OA-6/7/8A/8B - Background

OA-4/5-Background

1 NEW WORK PLAN - LEVEL 01 - OVERVIEW

Scale: 3/64" = 1'-0"

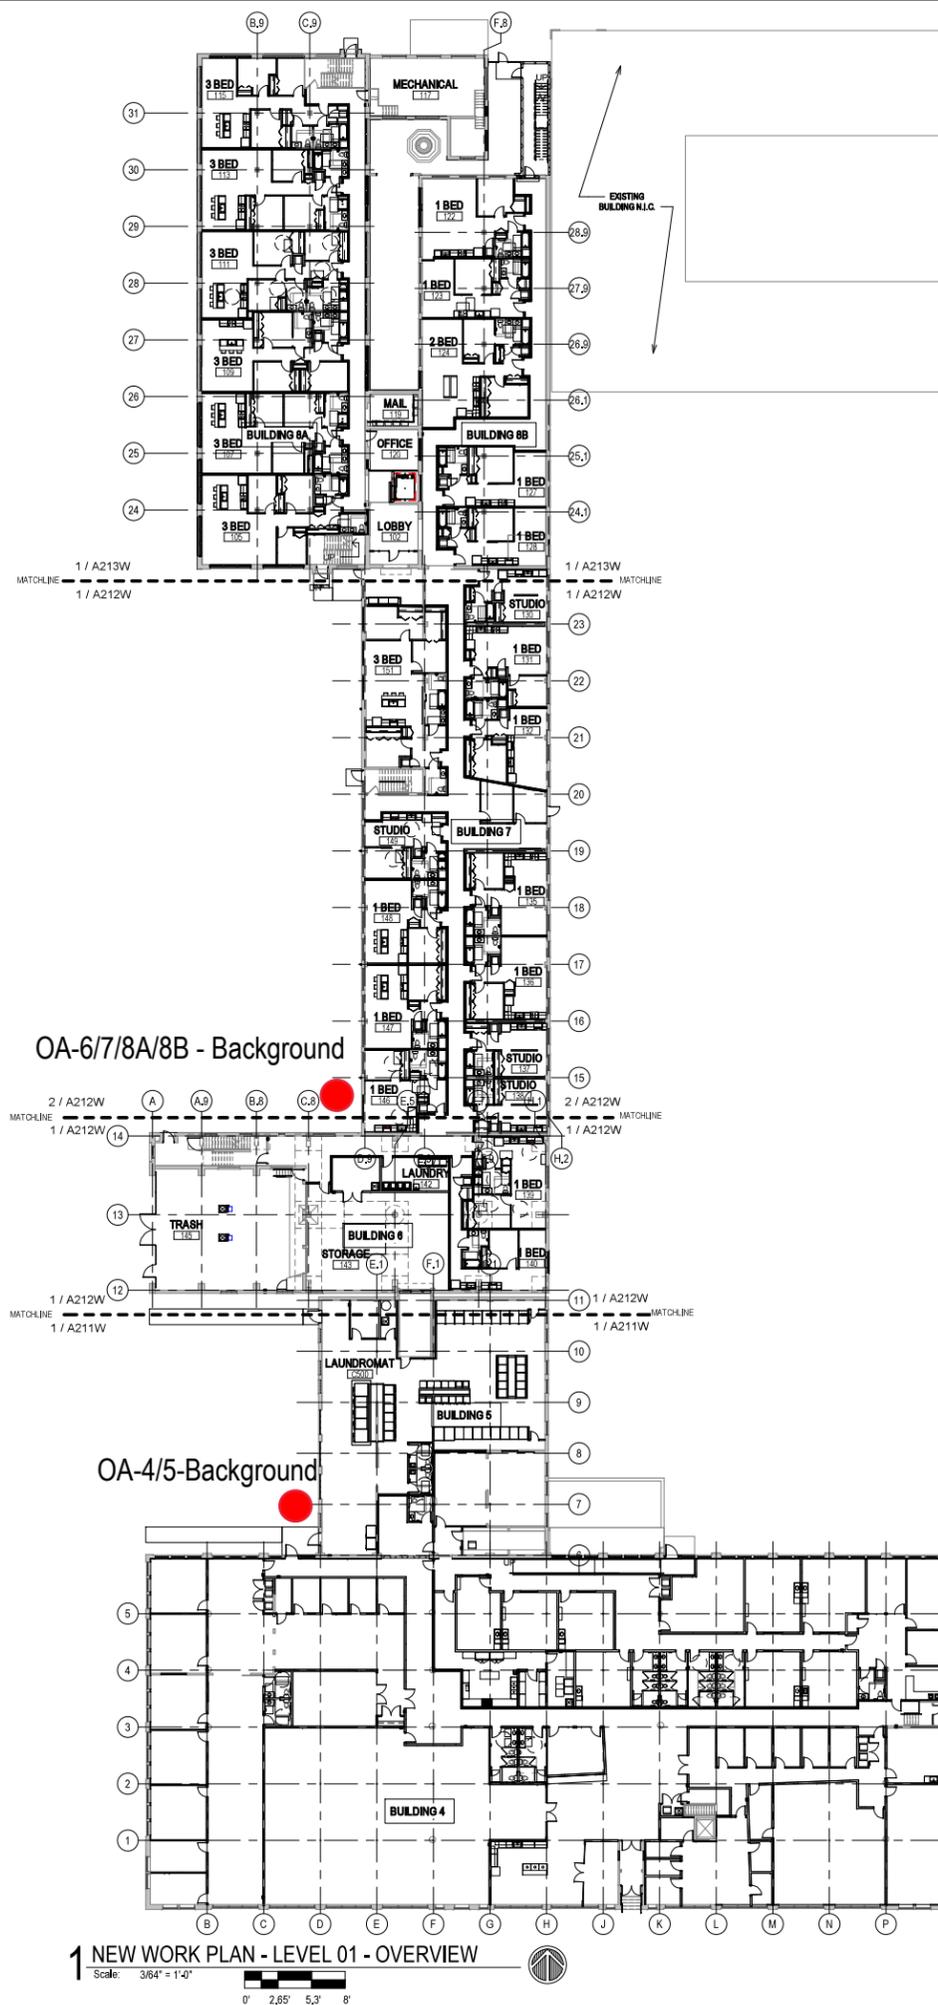

NEW WORK PLAN KEY NOTES - 1/8" PLANS

- SEE PROJECT GENERAL CONDITIONS, GENERAL INFORMATION ON SHEET A001W AND SELECTIVE DEMOLITION, CUTTING AND PATCHING SPECIFICATIONS THAT ARE USED IN ASSOCIATION WITH THESE NOTES.
- NEW WORK PLAN KEY NOTES APPLY TO ALL 1/8" NEW WORK DRAWINGS AND MAY NOT BE USED ON EVERY SHEET.
- 001 SEE UNIT 137 ENLARGED PLAN.
  - 002 SEE UNIT 105 ENLARGED PLAN.
  - 003 SEE UNIT 113 ENLARGED PLAN.
  - 004 SEE UNIT 116 ENLARGED PLAN. UNIT MAY BE MIRRORRED.
  - 005 SEE UNIT 149 ENLARGED PLAN.
  - 006 SEE UNIT 131 ENLARGED PLAN.
  - 007 SEE UNIT 132 ENLARGED PLAN.
  - 008 SEE UNIT 232 ENLARGED PLAN.
  - 009 SEE UNIT 251 ENLARGED PLAN.
  - 010 SEE UNIT 148 ENLARGED PLAN.
  - 011 SEE UNIT 151 ENLARGED PLAN.
  - 012 SEE UNIT 225 ENLARGED PLAN.
  - 013 SEE UNIT 242 ENLARGED PLAN.
  - 014 SEE UNIT 128 ENLARGED PLAN. UNIT MAY BE MIRRORRED.
  - 015 SEE UNIT 122 ENLARGED PLAN.
  - 016 SEE UNIT 221 ENLARGED PLAN.
  - 017 SEE UNIT 111 ENLARGED PLAN.
  - 018 SEE UNIT 217 ENLARGED PLAN.
  - 019 SEE UNIT 124 ENLARGED PLAN.
  - 020 SEE UNIT 224 ENLARGED PLAN.
  - 021 SEE UNIT 223 ENLARGED PLAN.
  - 022 SEE UNIT 109 ENLARGED PLAN.
  - 023 SEE UNIT 115 ENLARGED PLAN.
  - 024 SEE UNIT 130 ENLARGED PLAN. UNIT MAY BE MIRRORRED.
  - 025 SEE UNIT 215 ENLARGED PLAN.
  - 026 SEE UNIT 205 ENLARGED PLAN.
  - 027 SEE UNIT 314 ENLARGED PLAN.
  - 028 SEE UNIT 139 ENLARGED PLAN.
  - 029 SEE UNIT 140 ENLARGED PLAN.
  - 030 SEE UNIT 207 ENLARGED PLAN.
  - 031 SEE UNIT 213 ENLARGED PLAN. UNIT TO INCLUDE AUDIO AND VISUAL ALARM DEVICES FOR THE HEARING AND VISUALLY IMPAIRED. COORDINATE LOCATION WITH ELECTRICAL DRAWINGS.
  - 032 SEE UNIT 147 ENLARGED PLAN.
  - 033 SEE UNIT 127 ENLARGED PLAN.
  - 034 SEE UNIT 206 ENLARGED PLAN.
  - 035 NEW CONCRETE ON METAL DECK INFILL WITH SPRAY-APPLIED FIRE RESISTIVE MATERIAL AT NEW STEEL BEAMS AND ANGLES TO MAINTAIN FLOOR ASSEMBLY FIRE RATING. SEE OVERVIEW FLOOR PLANS FOR REQUIRED FLOOR ASSEMBLY FIRE RATINGS. SEE STRUCTURAL FOR DETAIL.
  - 036 NEW CONCRETE INFILL AT EXISTING PIT. MATCH ADJACENT FLOOR LEVEL, FINISH AND SURFACE TEXTURE.
  - 037 PATCH AND REPAIR DAMAGED CONCRETE SLAB MATCH ADJACENT FLOOR LEVEL, FINISH AND SURFACE TEXTURE.
  - 038 NEW TIMBER FLOOR DECK INFILL TO MATCH EXISTING. SEE STRUCTURAL.
  - 039 NEW CONCRETE INFILL SLAB AT EXISTING SUNKEN STAIR PIT. MATCH ADJACENT FLOOR LEVEL, FINISH AND SURFACE TEXTURE.
  - 040 PATCH & REPAIR CONCRETE SLAB WHERE EMBEDDED METAL PLATES AND/OR METAL TRENCH COVERS WERE REMOVED. FILL AND LEVEL WITH NEW CONCRETE TO MATCH ADJACENT SURFACE LEVEL AND FINISH TEXTURE. FEATHER CONCRETE TO LEVEL AT EXISTING METAL FLOOR OPENING FRAMES IF PRESENT.
  - 041 NEW INFILL WALL & PRECAST SILL TO REBUILD WINDOW OPENING. SEE ELEVATIONS. TOOTH IN SALVAGED BRICK WITH NEW MORTAR TO MATCH ADJACENT HISTORIC MASONRY.
  - 042 NEW INFILL WALL TO REBUILD WINDOW & DOOR OPENING. TOOTH IN SALVAGED MASONRY WITH NEW MORTAR TO MATCH ADJACENT HISTORIC MASONRY. PARGE SURFACES TO MATCH ADJACENT HISTORIC PARGE IF PRESENT.
  - 043 NEW PARTIAL INFILL WALL ASSEMBLY TO REBUILD OPENING IN EXISTING WALL BELOW SILL AT FLOOR LEVEL. SEE ELEVATIONS. TOOTH IN SALVAGED BRICK WITH NEW MORTAR TO MATCH ADJACENT HISTORIC MASONRY. SEE DETAIL 71AS10W FOR WALL ASSEMBLY.
  - 044 PATCH & REPAIR DAMAGED WALL OPENING AT SILL. TOOTH IN SALVAGED BRICK WITH NEW MORTAR AND PROVIDE NEW SILL TO MATCH ADJACENT HISTORIC MASONRY.
  - 045 PATCH & REPAIR DAMAGED AND MISSING PLASTER RETURNS AT JAMB, HEAD AND SILL TO MATCH EXISTING RETURNS. SEE WINDOW DETAILS. AT THESE WALLS THERE WILL BE A FURRING WITH 3/8" GWS EXTENDING FROM FLOOR TO TOP OF WALL AT UNDERSIDE OF STRUCTURE.
  - 046 PATCH & REPAIR DAMAGED AND MISSING PLASTER WOOD LATH FURRING WALL. PATCH AND REPAIR EXISTING RADICUSED PLASTER RETURN PROFILES IF DAMAGED AT JAMB, HEAD AND SILL TO MATCH EXISTING RETURNS AT ADJACENT WINDOWS OF THE SAME TYPE.
  - 047 NEW GYPSUM BOARD INFILL WALL ASSEMBLY AT EXISTING OPENING. SEE DETAIL 1A170W.
  - 048 NEW CMU INFILL WALL ASSEMBLY AT EXISTING OPENING. SEE DETAIL 2A170W.
  - 049 NEW GYPSUM BOARD INFILL WALL ASSEMBLY AT EXISTING NON-HISTORIC WALL OPENING. MATCH EXISTING WALL ASSEMBLY WIDTH AND ADJACENT SURFACE FINISH.
  - 050 NEW METAL PANEL INFILL WALL ASSEMBLY AT EXISTING EXTERIOR MASONRY WALL OPENING. SEE DETAIL 5AS10W.


NEW WORK PLAN KEY NOTES - 1/8" PLANS

- SEE PROJECT GENERAL CONDITIONS, GENERAL INFORMATION ON SHEET A001W AND SELECTIVE DEMOLITION, CUTTING AND PATCHING SPECIFICATIONS THAT ARE USED IN ASSOCIATION WITH THESE NOTES.
- NEW WORK PLAN KEY NOTES APPLY TO ALL 1/8" NEW WORK DRAWINGS AND MAY NOT BE USED ON EVERY SHEET.
- 051 NEW METAL PANEL INFILL WALL ASSEMBLY AT EXISTING WINDOW OPENING. SEE DETAIL 5AS10W.
  - 052 EXISTING HISTORIC SLIDING FIRE DOOR ASSEMBLY TO REMAIN. SECURE SLIDING DOOR IN A FULLY OPEN POSITION WITH METAL Z-BRACKETS. PREPARE ENTIRE ASSEMBLY FOR PAINTED FINISH.
  - 053 EXISTING HISTORIC SLIDING FIRE DOOR ASSEMBLY TO REMAIN. SECURE SLIDING DOOR IN A CLOSED POSITION WITH METAZ Z-BRACKETS. PREPARE ENTIRE ASSEMBLY FOR NEW PAINTED FINISH.
  - 054 REINSTALL SALVAGED HISTORIC SLIDING FIRE DOOR ASSEMBLY AND HARDWARE FROM THIS OPENING TO NEW ORIENTATION AS SHOWN. SECURE SLIDING DOOR IN A CLOSED POSITION WITH METAL Z-BRACKETS. PREPARE ENTIRE ASSEMBLY FOR NEW PAINTED FINISH.
  - 055 EXISTING HISTORIC COILING OVERHEAD DOOR ASSEMBLY TO REMAIN. SECURE COILING DOOR IN A FULLY CLOSED POSITION. PREPARE ENTIRE ASSEMBLY FOR PAINTED FINISH.
  - 056 EXISTING HISTORIC COILING OVERHEAD DOOR ASSEMBLY TO REMAIN. REPAIR TRACK AND HARDWARE TO RETURN DOOR TO OPERATING CONDITION. PREPARE ENTIRE ASSEMBLY FOR PAINTED FINISH.
  - 057 EXISTING HISTORIC STEEL SASH WINDOW ASSEMBLY TO REMAIN. PREPARE ENTIRE ASSEMBLY FOR PAINTED FINISH. REPLACE BROKEN OR MISSING PANE OF GLASS WITH NEW GLASS TO MATCH EXISTING.
  - 058 NEW OPENING IN EXISTING CMU WALL. TOOTH IN NEW CMU AND MORTAR TO MATCH EXISTING.
  - 059 EXISTING GLAZED WALL TILE TO REMAIN. PROTECT DURING CONSTRUCTION.
  - 060 TUCKPOINT AND REPAIR EXISTING CHIMNEY TO MATCH EXISTING MATERIALS. SEE EXTERIOR MASONRY REPORT AND DRAWINGS.
  - 061 EXISTING WOOD SINGLE HUNG WINDOW FRAME, SASH AND ALL CASING/TRIM TO REMAIN. PREPARE EXISTING INTERIOR & EXTERIOR SURFACES FOR NEW PAINT. REPLACE MISSING AND/OR BROKEN GLASS TO MATCH EXISTING AND INSTALL NEW GLAZING PANE OF GLASS WITH NEW GLASS TO MATCH EXISTING.
  - 062 ALIGN EDGE OF DEMISING WALL WITH EDGE OF HISTORIC MASONRY OPENING.
  - 063 ALIGN CENTER OF DEMISING WALL OR PARTITION WITH CENTERLINE OF HISTORIC COLUMN, OR BEAM ABOVE.
  - 064 ALIGN EDGE OF DEMISING WALL WITH EDGE OF HISTORIC CONCRETE DROP SLAB.
  - 065 ALIGN CENTER OF DEMISING WALL PARTITION WITH CENTERLINE OF WINDOW MULLION.
  - 066 ALIGN EDGE OF DEMISING WALL WITH OUTER EDGE OF LIGHT MONITOR COLUMN.
  - 067 ALIGN CENTER OF DEMISING WALL OR PARTITION WITH CENTER OF HISTORIC SKYLIGHT MULLION ABOVE.
  - 068 NEW 3X6 ACCESS DOOR W/ 3-HR RATING @ WALL TO ABANDONED MECHANICAL TUNNEL.
  - 069 NEW CONCRETE SLAB AT EXISTING STOOP TO MATCH FLOOR HEIGHT AT BUILDING 7. SEE STRUCTURAL.
  - 070 EXISTING WOOD STAIR, GUARD AND HANDRAIL TO REMAIN. PREP ALL SURFACES FOR NEW PAINT.
  - 071 EXISTING WOOD STAIR, GUARD AND HANDRAIL TO REMAIN. REPAIR/REPLACE MISSING BEAD BOARD HANDRAIL SUPPORT AND STAIR RUN FROM LEVEL 01 TO 1ST LANDING TO MATCH EXISTING HISTORIC CONDITION PERCENT. PROVIDE NEW STEEL HANDRAILS AT EXISTING CMU WALLS. PREP ALL SURFACES FOR NEW PAINT.
  - 072 EXISTING CONCRETE STAIR, CMU GUARD AND HANDRAIL TO REMAIN. PREP ALL SURFACES FOR NEW FINISHES.
  - 073 PROVIDE NEW EGRESS BARRIER GATE AT EXISTING STEEL GUARDRAIL. EXISTING CONCRETE STAIR, STEEL GUARDRAIL AND HANDRAIL TO REMAIN. PREP ALL SURFACES FOR NEW FINISHES.
  - 074 NEW CONCRETE STAIR, GUARD AND HANDRAILS TO REMAIN. PREP ALL SURFACES FOR NEW PAINT.
  - 075 BUILD TYPE P6 UNIT DEMISING WALL WITH RESILIENT CHANNEL ON THIS SIDE.
  - 076 TAPER GYPCRETE TOPPING 1:20 SLOPE MAX TO MEET EXISTING FINISH LEVEL AT TRANSITION AREA TO STAIRS OR BETWEEN BUILDINGS.
  - 077 TAPER POLISHED EPOXY FLOOR TOPPING TO TRANSITION FLOOR FINISH LEVEL CHANGE BETWEEN BUILDINGS 6 & 7.
  - 078 TAPER 1:20 SLOPE MAX.
  - 079 PATCH AND REPAIR DAMAGED AND MISSING EXTERIOR STUCCO TO MATCH ADJACENT SURFACE.

GENERAL FLOOR PLAN NOTES TO CONTRACTOR

1. THIS DRAWING IS FURTHER SUPPORTED BY INFORMATION CONTAINED IN THE SPECIFICATION MANUAL.
2. THE CIVIL, STRUCTURAL, MECHANICAL, ELECTRICAL, PLUMBING, FIRE PROTECTION, AUDIO-VISUAL, AND SECURITY DRAWINGS ARE SUPPLEMENTARY TO THE ARCHITECTURAL DRAWINGS. IT SHALL BE THE RESPONSIBILITY OF THE CONTRACTOR TO COORDINATE THE INFORMATION CONTAINED IN ALL THE DRAWINGS BEFORE THE INSTALLATION OF ALL WORK.
3. DO NOT SCALE DRAWINGS. CONTRACTOR TO VERIFY ALL CONDITIONS AND DIMENSIONS AT THE JOB SITE PRIOR TO COMMENCING CONSTRUCTION.
4. FLOOR ELEVATIONS ARE TO THE TOP OF THE SUB-FLOOR MATERIAL UNLESS OTHERWISE NOTED.
5. CONTRACTORS SHALL JOINTLY PROVIDE AND INSTALL ALL STIFFENERS, BRACING, BANDING PLATES, WALL BLOCKING AND SUPPORTING BRACKETS REQUIRED FOR THE INSTALLATION OF CASEWORK, TOILET ACCESSORIES, PARTITIONS, MILLWORK, AND ALL WORK MOUNTED OR SUSPENDED BY ALL TRADES.

NEW WORK PLAN LEGEND

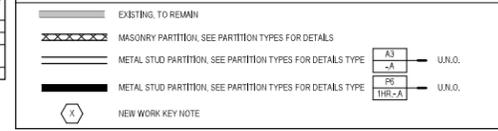

PATCH AND INFILL LEGEND



FLOOR ASSEMBLY SUMMARY

	LEVEL 01	LEVEL 02	LEVEL 03
BLDG. 4 MAIN AREA	EXISTING CONCRETE SLAB-ON-GRADE		
BLDG. 4 AT PARTIAL BASEMENT	-EXISTING 6" CONCRETE SLAB -ASSEMBLY FIRE RATING: 1 HOUR		
BLDG. 5	EXISTING CONCRETE SLAB-ON-GRADE		
BLDG. 6	-EXISTING 10 1/2" CONCRETE SLAB -ASSEMBLY FIRE RATING: 1 HOUR	-EXISTING 10 1/2" CONCRETE SLAB -ASSEMBLY FIRE RATING: 1 HOUR -STC-B RATING	
BLDG. 7	EXISTING CONCRETE SLAB-ON-GRADE	-FINISH FLOORING (SEE FINISH PLANS FOR MATERIALS AND LOCATIONS OF FINISH MATERIALS) -NEW 1-1/2" GYPSUM CEMENT UNDERLAYMENT -NEW ACOUSTIC SOUND MAT (AT NON-CARPETED AREAS ONLY) -EXISTING 2" TIMBER SUBFLOORING -EXISTING 7X13 TIMBER FLOOR JOISTS (NDS CH. 16 CALCULATED CHAR RATE MEETS 12-HOUR RATING) -UNDERSIDE OF EXISTING WOOD SUBFLOORING TO RECEIVE NEW INTUIMESCENT COATING. -ASSEMBLY FIRE RATING: 12 HOUR -FSTC: 45-49 FRC: 45-47	
BLDG. 8A	-FINISH FLOORING (SEE FINISH PLANS FOR MATERIALS AND LOCATIONS OF FINISH MATERIALS) -EXISTING CONCRETE SLAB ON GRADE	-FINISH FLOORING (SEE FINISH PLANS FOR MATERIALS AND LOCATIONS OF FINISH MATERIALS) -NEW 1-1/2" GYPSUM CEMENT UNDERLAYMENT -NEW ACOUSTIC SOUND MAT (AT NON-CARPETED AREAS ONLY) -EXISTING 3" TIMBER SUBFLOORING (NDS CH. 16 CALCULATED CHAR RATE MEETS 12-HOUR RATING) -EXISTING 6X14 TIMBER FLOOR JOIST (NDS CH. 16 CALCULATED CHAR RATE MEETS 12-HOUR RATING) -ASSEMBLY FIRE RATING: 12 HOUR -FSTC: 45-49 FRC: 45-47	-FINISH FLOORING (SEE FINISH PLANS FOR MATERIALS AND LOCATIONS OF FINISH MATERIALS) -NEW 1-1/2" GYPSUM CEMENT UNDERLAYMENT -NEW ACOUSTIC SOUND MAT (AT NON-CARPETED AREAS ONLY) -EXISTING 3" TIMBER SUBFLOORING (NDS CH. 16 CALCULATED CHAR RATE MEETS 12-HOUR RATING) -EXISTING 6X14 TIMBER FLOOR JOIST (NDS CH. 16 CALCULATED CHAR RATE MEETS 12-HOUR RATING) -ASSEMBLY FIRE RATING: 12 HOUR -FSTC: 45-49 FRC: 45-47
BLDG. 8A @ ELEVATOR CORE	EXISTING CONCRETE SLAB-ON-GRADE	-EXISTING 3" CONCRETE SLAB -EXISTING 10" CLAY TILE INFILL -ASSEMBLY FIRE RATING: 1 HOUR	-EXISTING 3" CONCRETE SLAB -EXISTING 10" CLAY TILE INFILL -ASSEMBLY FIRE RATING: 1 HOUR
BLDG. 8B	EXISTING CONCRETE SLAB-ON-GRADE	-FINISH FLOORING (SEE FINISH PLANS FOR MATERIALS AND LOCATIONS OF FINISH MATERIALS) -NEW 1-1/2" GYPSUM CEMENT UNDERLAYMENT -NEW ACOUSTIC SOUND MAT (AT NON-CARPETED AREAS ONLY) -EXISTING 3" TIMBER SUBFLOORING (NDS CH. 16 CALCULATED CHAR RATE MEETS 12-HOUR RATING) -EXISTING 8X14 TIMBER FLOOR JOIST (NDS CH. 16 CALCULATED CHAR RATE MEETS 12-HOUR RATING) -ASSEMBLY FIRE RATING: 12 HOUR -FSTC: 45-49 FRC: 45-47	

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SHEET TITLE  
NEW WORK PLAN - LEVEL 01 - OVERVIEW ALL BUILDINGS

REVISIONS

1 10/09/20 ADDENDUM #1


SCALE VARIES

PROJECT NUMBER 200102

SET TYPE CONSTRUCTION DOCUMENTS

DATE ISSUED 9/25/20

SHEET NUMBER A210W

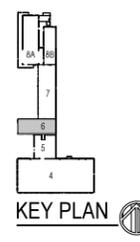

**PATCH AND INFILL LEGEND**

	CONCRETE FLOOR OPENING INFILL. SEE STRUCTURAL FOR INFILL CONDITIONS, V.I.F. EXACT SIZE AND LOCATIONS.
	CONCRETE FLOOR COSMETIC PATCH. V.I.F. EXACT SIZE AND LOCATIONS.
	WOOD FLOOR STRUCTURAL INFILL. SEE STRUCTURAL FOR INFILL CONDITIONS, V.I.F. EXACT SIZE AND LOCATIONS.

**NEW WORK PLAN KEY NOTES - 1/8" PLANS**

SEE PROJECT GENERAL CONDITIONS, GENERAL INFORMATION ON SHEET A001W AND SELECTIVE DEMOLITION, CUTTING AND PATCHING SPECIFICATIONS THAT ARE USED IN ASSOCIATION WITH THESE NOTES.

NEW WORK PLAN KEY NOTES APPLY TO ALL 1/8" NEW WORK DRAWINGS AND MAY NOT BE USED ON EVERY SHEET.

- SEE UNIT 137 ENLARGED PLAN.
- SEE UNIT 105 ENLARGED PLAN.
- SEE UNIT 113 ENLARGED PLAN.
- SEE UNIT 138 ENLARGED PLAN. UNIT MAY BE MIRRORED.
- SEE UNIT 140 ENLARGED PLAN.
- SEE UNIT 131 ENLARGED PLAN.
- SEE UNIT 132 ENLARGED PLAN.
- SEE UNIT 232 ENLARGED PLAN.
- SEE UNIT 251 ENLARGED PLAN.
- SEE UNIT 146 ENLARGED PLAN.
- SEE UNIT 151 ENLARGED PLAN.
- SEE UNIT 232 ENLARGED PLAN.
- SEE UNIT 242 ENLARGED PLAN.
- SEE UNIT 128 ENLARGED PLAN. UNIT MAY BE MIRRORED.
- SEE UNIT 132 ENLARGED PLAN.
- SEE UNIT 224 ENLARGED PLAN.
- SEE UNIT 223 ENLARGED PLAN.
- SEE UNIT 111 ENLARGED PLAN.
- SEE UNIT 217 ENLARGED PLAN.
- SEE UNIT 124 ENLARGED PLAN.
- SEE UNIT 224 ENLARGED PLAN.
- SEE UNIT 223 ENLARGED PLAN.
- SEE UNIT 109 ENLARGED PLAN.
- SEE UNIT 115 ENLARGED PLAN.
- SEE UNIT 130 ENLARGED PLAN. UNIT MAY BE MIRRORED.
- SEE UNIT 173 ENLARGED PLAN.
- SEE UNIT 205 ENLARGED PLAN.
- SEE UNIT 314 ENLARGED PLAN.
- SEE UNIT 139 ENLARGED PLAN.
- SEE UNIT 140 ENLARGED PLAN.
- SEE UNIT 207 ENLARGED PLAN.
- SEE UNIT 213 ENLARGED PLAN. UNIT TO INCLUDE AUDIO AND VISUAL ALARM DEVICES FOR THE HEARING AND VISUALLY IMPAIRED. COORDINATE LOCATION WITH ELECTRICAL DRAWINGS.
- SEE UNIT 142 ENLARGED PLAN.
- SEE UNIT 132 ENLARGED PLAN.
- SEE UNIT 206 ENLARGED PLAN.
- NEW CONCRETE ON METAL DECK INFILL WITH SPRAY-APPLIED FIRE RESISTIVE MATERIAL AT NEW STEEL BEAMS AND ANGLES TO MAINTAIN FLOOR ASSEMBLY FIRE RATING. SEE OVERVIEW FLOOR PLANS FOR REQUIRED FLOOR ASSEMBLY FIRE RATINGS. SEE STRUCTURAL FOR DETAIL.
- NEW TIMBER FLOOR DECK INFILL TO MATCH EXISTING. SEE STRUCTURAL.
- NEW CONCRETE INFILL SLAB AT EXISTING SUNKEN STAIR PIT. MATCH ADJACENT FLOOR LEVEL, FINISH AND SURFACE TEXTURE.
- PATCH & REPAIR CONCRETE SLAB WHERE EMBEDDED METAL PLATES AND/OR METAL TRENCH COVERS WERE REMOVED. FILL AND LEVEL WITH NEW CONCRETE TO MATCH ADJACENT SURFACE LEVEL AND FINISH TEXTURE. FEATHER CONCRETE TO LEVEL AT EXISTING METAL FLOOR OPENING FRAMES IF PRESENT.
- NEW INFILL WALL & PRECAST SILL TO REBUILD WINDOW OPENING. SEE ELEVATIONS. TOOTH IN SALVAGED BRICK WITH NEW MORTAR TO MATCH ADJACENT HISTORIC MASONRY.
- NEW INFILL WALL TO REBUILD WINDOW & DOOR OPENING. TOOTH IN SALVAGED MASONRY WITH NEW MORTAR TO MATCH ADJACENT HISTORIC MASONRY. PARGE SURFACES TO MATCH ADJACENT HISTORIC PARGE IF PRESENT.
- NEW PARTIAL INFILL WALL ASSEMBLY TO REBUILD OPENING IN EXISTING WALL BELOW SILL AT FLOOR LEVEL. SEE ELEVATIONS. TOOTH IN SALVAGED BRICK WITH NEW MORTAR TO MATCH ADJACENT HISTORIC MASONRY. SEE DETAIL 13A10W FOR WALL ASSEMBLY.
- PATCH & REPAIR DAMAGED WALL OPENING AT SILL. TOOTH IN SALVAGED BRICK WITH NEW MORTAR AND PROVIDE NEW SILL TO MATCH ADJACENT HISTORIC MASONRY.
- PATCH & REPAIR DAMAGED AND MISSING PLASTER RETURNS AT JAMB, HEAD AND SILL TO MATCH EXISTING RETURNS. SEE WINDOW DETAILS. AT THESE WALLS THERE WILL BE A PURGING WITH 5/8" GIBS EXTENDING FROM FLOOR TO TOP OF WALL AT UNDERSIDE OF STRUCTURE.
- PATCH & REPAIR DAMAGED AND MISSING PLASTER WOOD LATH FURRING WALL. PATCH AND REPAIR EXISTING RADIUSED PLASTER RETURN PROFILES IF DAMAGED AT JAMB, HEAD AND SILL TO MATCH EXISTING RETURNS AT ADJACENT WINDOWS OF THE SAME TYPE.
- NEW GYPSUM BOARD INFILL WALL ASSEMBLY AT EXISTING OPENING. SEE DETAIL 14A10W.
- NEW CMU INFILL WALL ASSEMBLY AT EXISTING OPENING. SEE DETAIL 24A10W.
- NEW GYPSUM BOARD INFILL WALL ASSEMBLY AT EXISTING NON-HISTORIC WALL OPENING. MATCH EXISTING WALL ASSEMBLY WIDTH AND ADJACENT SURFACE FINISH.
- NEW METAL PANEL INFILL WALL ASSEMBLY AT EXISTING EXTERIOR MASONRY WALL OPENING. SEE DETAIL 5A10W.

**NEW WORK PLAN KEY NOTES - 1/8" PLANS**

SEE PROJECT GENERAL CONDITIONS, GENERAL INFORMATION ON SHEET A001W AND SELECTIVE DEMOLITION, CUTTING AND PATCHING SPECIFICATIONS THAT ARE USED IN ASSOCIATION WITH THESE NOTES.

NEW WORK PLAN KEY NOTES APPLY TO ALL 1/8" NEW WORK DRAWINGS AND MAY NOT BE USED ON EVERY SHEET.

- NEW METAL PANEL INFILL WALL ASSEMBLY AT EXISTING WINDOW OPENING. SEE DETAIL 5A10W.
- EXISTING HISTORIC SLIDING FIRE DOOR ASSEMBLY TO REMAIN. SECURE SLIDING DOOR IN A FULLY OPEN POSITION WITH METAL Z-BRACKETS. PREPARE ENTIRE ASSEMBLY FOR PAINTED FINISH.
- EXISTING HISTORIC SLIDING FIRE DOOR ASSEMBLY TO REMAIN. SECURE SLIDING DOOR IN A CLOSED POSITION WITH METAL Z-BRACKETS. PREPARE ENTIRE ASSEMBLY FOR NEW PAINTED FINISH.
- REINSTALL SALVAGED HISTORIC SLIDING FIRE DOOR ASSEMBLY AND HARDWARE FROM THIS OPENING TO NEW ORIENTATION AS SHOWN. SECURE SLIDING DOOR IN A CLOSED POSITION WITH METAL Z-BRACKETS. PREPARE ENTIRE ASSEMBLY FOR NEW PAINTED FINISH.
- EXISTING HISTORIC COILING OVERHEAD DOOR ASSEMBLY TO REMAIN. SECURE COILING DOOR IN A FULLY OPEN POSITION. PREPARE ENTIRE ASSEMBLY FOR PAINTED FINISH.
- EXISTING HISTORIC COILING OVERHEAD DOOR ASSEMBLY TO REMAIN. SECURE COILING DOOR IN A FULLY CLOSED POSITION. PREPARE ENTIRE ASSEMBLY FOR PAINTED FINISH.
- EXISTING HISTORIC OVERHEAD DOOR ASSEMBLY TO REMAIN. REPAIR TRACK AND HARDWARE TO RETURN DOOR TO OPERATING CONDITION. PREPARE ENTIRE ASSEMBLY FOR PAINTED FINISH.
- EXISTING STEEL SASH WINDOW ASSEMBLY TO REMAIN. PREPARE ENTIRE ASSEMBLY FOR PAINTED FINISH. REPLACE BROKEN OR MISSING PANE OF GLASS WITH NEW GLASS TO MATCH EXISTING.
- NEW OPENING IN EXISTING CMU WALL. TOOTH IN NEW CMU AND MORTAR TO MATCH EXISTING.
- EXISTING GLAZED WALL TILE TO REMAIN. PROTECT DURING CONSTRUCTION.
- TILKPOINT AND REPAIR EXISTING CHIMNEY TO MATCH EXISTING MATERIALS. SEE EXTERIOR MASONRY REPORT AND DRAWINGS.
- EXISTING WOOD SINGLE HUNG WINDOW FRAME, SASH AND ALL CASING/TRIM TO REMAIN. REPAIR EXISTING INTERIOR & EXTERIOR SURFACES FOR NEW PAINT. REPLACE MISSING AND/OR BROKEN GLASS TO MATCH EXISTING AND INSTALL NEW GLAZING PUTTY AT ALL PANELS. INSTALL NEW INTERIOR STORM WINDOWS. SEE DETAIL 13A10W.
- ALIGN EDGE OF DEMISING WALL WITH EDGE OF HISTORIC MASONRY OPENING.
- ALIGN CENTER OF DEMISING WALL OR PARTITION WITH CENTERLINE OF HISTORIC COLUMN OR BEAM ABOVE.
- ALIGN EDGE OF DEMISING WALL WITH EDGE OF HISTORIC CONCRETE DROP SLAB.
- ALIGN CENTER OF DEMISING WALL PARTITION WITH CENTERLINE OF WINDOW MULLION.
- ALIGN EDGE OF DEMISING WALL WITH OUTER EDGE OF LIGHT MONITOR VOLUME.
- ALIGN CENTER OF DEMISING WALL OR PARTITION WITH CENTER OF HISTORIC SKYLIGHT MULLION ABOVE.
- NEW 3'X3' ACCESS DOOR W/ 3HR RATING @ WALL TO ABANDONED MECHANICAL TUNNEL.
- NEW CONCRETE SLAB AT EXISTING STOOD TO MATCH FLOOR HEIGHT AT BUILDING 7. SEE STRUCTURAL.
- EXISTING WOOD STAIR. GUARD AND HANDRAIL TO REMAIN. REPAIR/REPLACE MISSING BEAD BOARD HANDRAIL SUPPORT AND STAIR RUN FROM LEVEL 01 TO 1ST LANDING TO MATCH EXISTING HISTORIC CONDITION PERSENT. PROVIDE NEW STEEL HANDRAIL AT EXISTING CMU GUARD AND HANDRAILS. PREP ALL SURFACES FOR NEW PAINT.
- EXISTING CONCRETE STAIR. CMU GUARD WALL AND HANDRAIL TO REMAIN. PREP ALL SURFACES FOR NEW FINISHES.
- PROVIDE NEW EGRESS BARRIER GATE AT EXISTING STEEL GUARDRAIL. EXISTING CONCRETE STAIR, STEEL GUARDRAIL AND HANDRAIL TO REMAIN. PREP ALL SURFACES FOR NEW FINISHES.
- NEW CONCRETE STAIR. GUARD AND HANDRAILS TO REMAIN. REPAIR/REPLACE MISSING BEAD BOARD HANDRAIL SUPPORT AND STAIR RUN FROM LEVEL 01 TO 1ST LANDING TO MATCH EXISTING HISTORIC CONDITION PERSENT. PROVIDE NEW STEEL HANDRAIL AT EXISTING CMU GUARD AND HANDRAILS. PREP ALL SURFACES FOR NEW PAINT.
- BUILD TYPE PB UNIT DEMISING WALL WITH RESILIENT CHANNEL ON THIS SIDE.
- NEW CONCRETE ON METAL DECK INFILL WITH SPRAY-APPLIED FIRE RESISTIVE MATERIAL AT NEW STEEL BEAMS AND ANGLES TO MAINTAIN FLOOR ASSEMBLY FIRE RATING. SEE OVERVIEW FLOOR PLANS FOR REQUIRED FLOOR ASSEMBLY FIRE RATINGS. SEE STRUCTURAL FOR DETAIL.
- NEW TAPERED POLISHED EPOXY FLOOR TOPPING TO TRANSITION FLOOR FINISH LEVEL CHANGE BETWEEN BUILDINGS 6 & 7. TAPER 1:20 SLOPE MAX.
- PATCH & REPAIR DAMAGED AND MISSING EXTERIOR STUCCO TO MATCH ADJACENT SURFACE.



**GENERAL FLOOR PLAN NOTES TO CONTRACTOR**

- THIS DRAWING IS FURTHER SUPPORTED BY INFORMATION CONTAINED IN THE SPECIFICATION MANUAL.
- THE CIVIL, STRUCTURAL, MECHANICAL, ELECTRICAL, PLUMBING, FIRE PROTECTION, AUDIO-VISUAL AND SECURITY DRAWINGS ARE SUPPLEMENTARY TO THE ARCHITECTURAL DRAWINGS. IT SHALL BE THE RESPONSIBILITY OF THE CONTRACTOR TO COORDINATE THE INFORMATION CONTAINED IN ALL THE DRAWINGS BEFORE THE INSTALLATION OF ALL WORK.
- DO NOT SCALE DRAWINGS. CONTRACTOR TO VERIFY ALL CONDITIONS AND DIMENSIONS AT THE JOB SITE PRIOR TO COMMENCING CONSTRUCTION.
- FLOOR ELEVATIONS ARE TO THE TOP OF THE SUB-FLOOR MATERIAL UNLESS OTHERWISE NOTED.
- CONTRACTORS SHALL JOINTLY PROVIDE AND INSTALL ALL STIFFENERS, BRACING, BACKING PLATES, WALL BLOCKING AND SUPPORTING BRACKETS REQUIRED FOR THE INSTALLATION OF CASEWORK, TOILET ACCESSORIES, PARTITIONS, MILLWORK AND ALL WORK MOUNTED OR SUSPENDED BY ALL TRADES.

**NEW WORK PLAN LEGEND**

	EXISTING TO REMAIN
	MASONRY PARTITION. SEE PARTITION TYPES FOR DETAILS
	METAL STUD PARTITION. SEE PARTITION TYPES FOR DETAILS TYPE
	METAL STUD PARTITION. SEE PARTITION TYPES FOR DETAILS TYPE

NEW WORK KEY NOTE

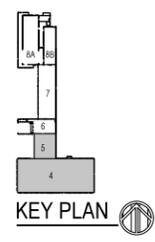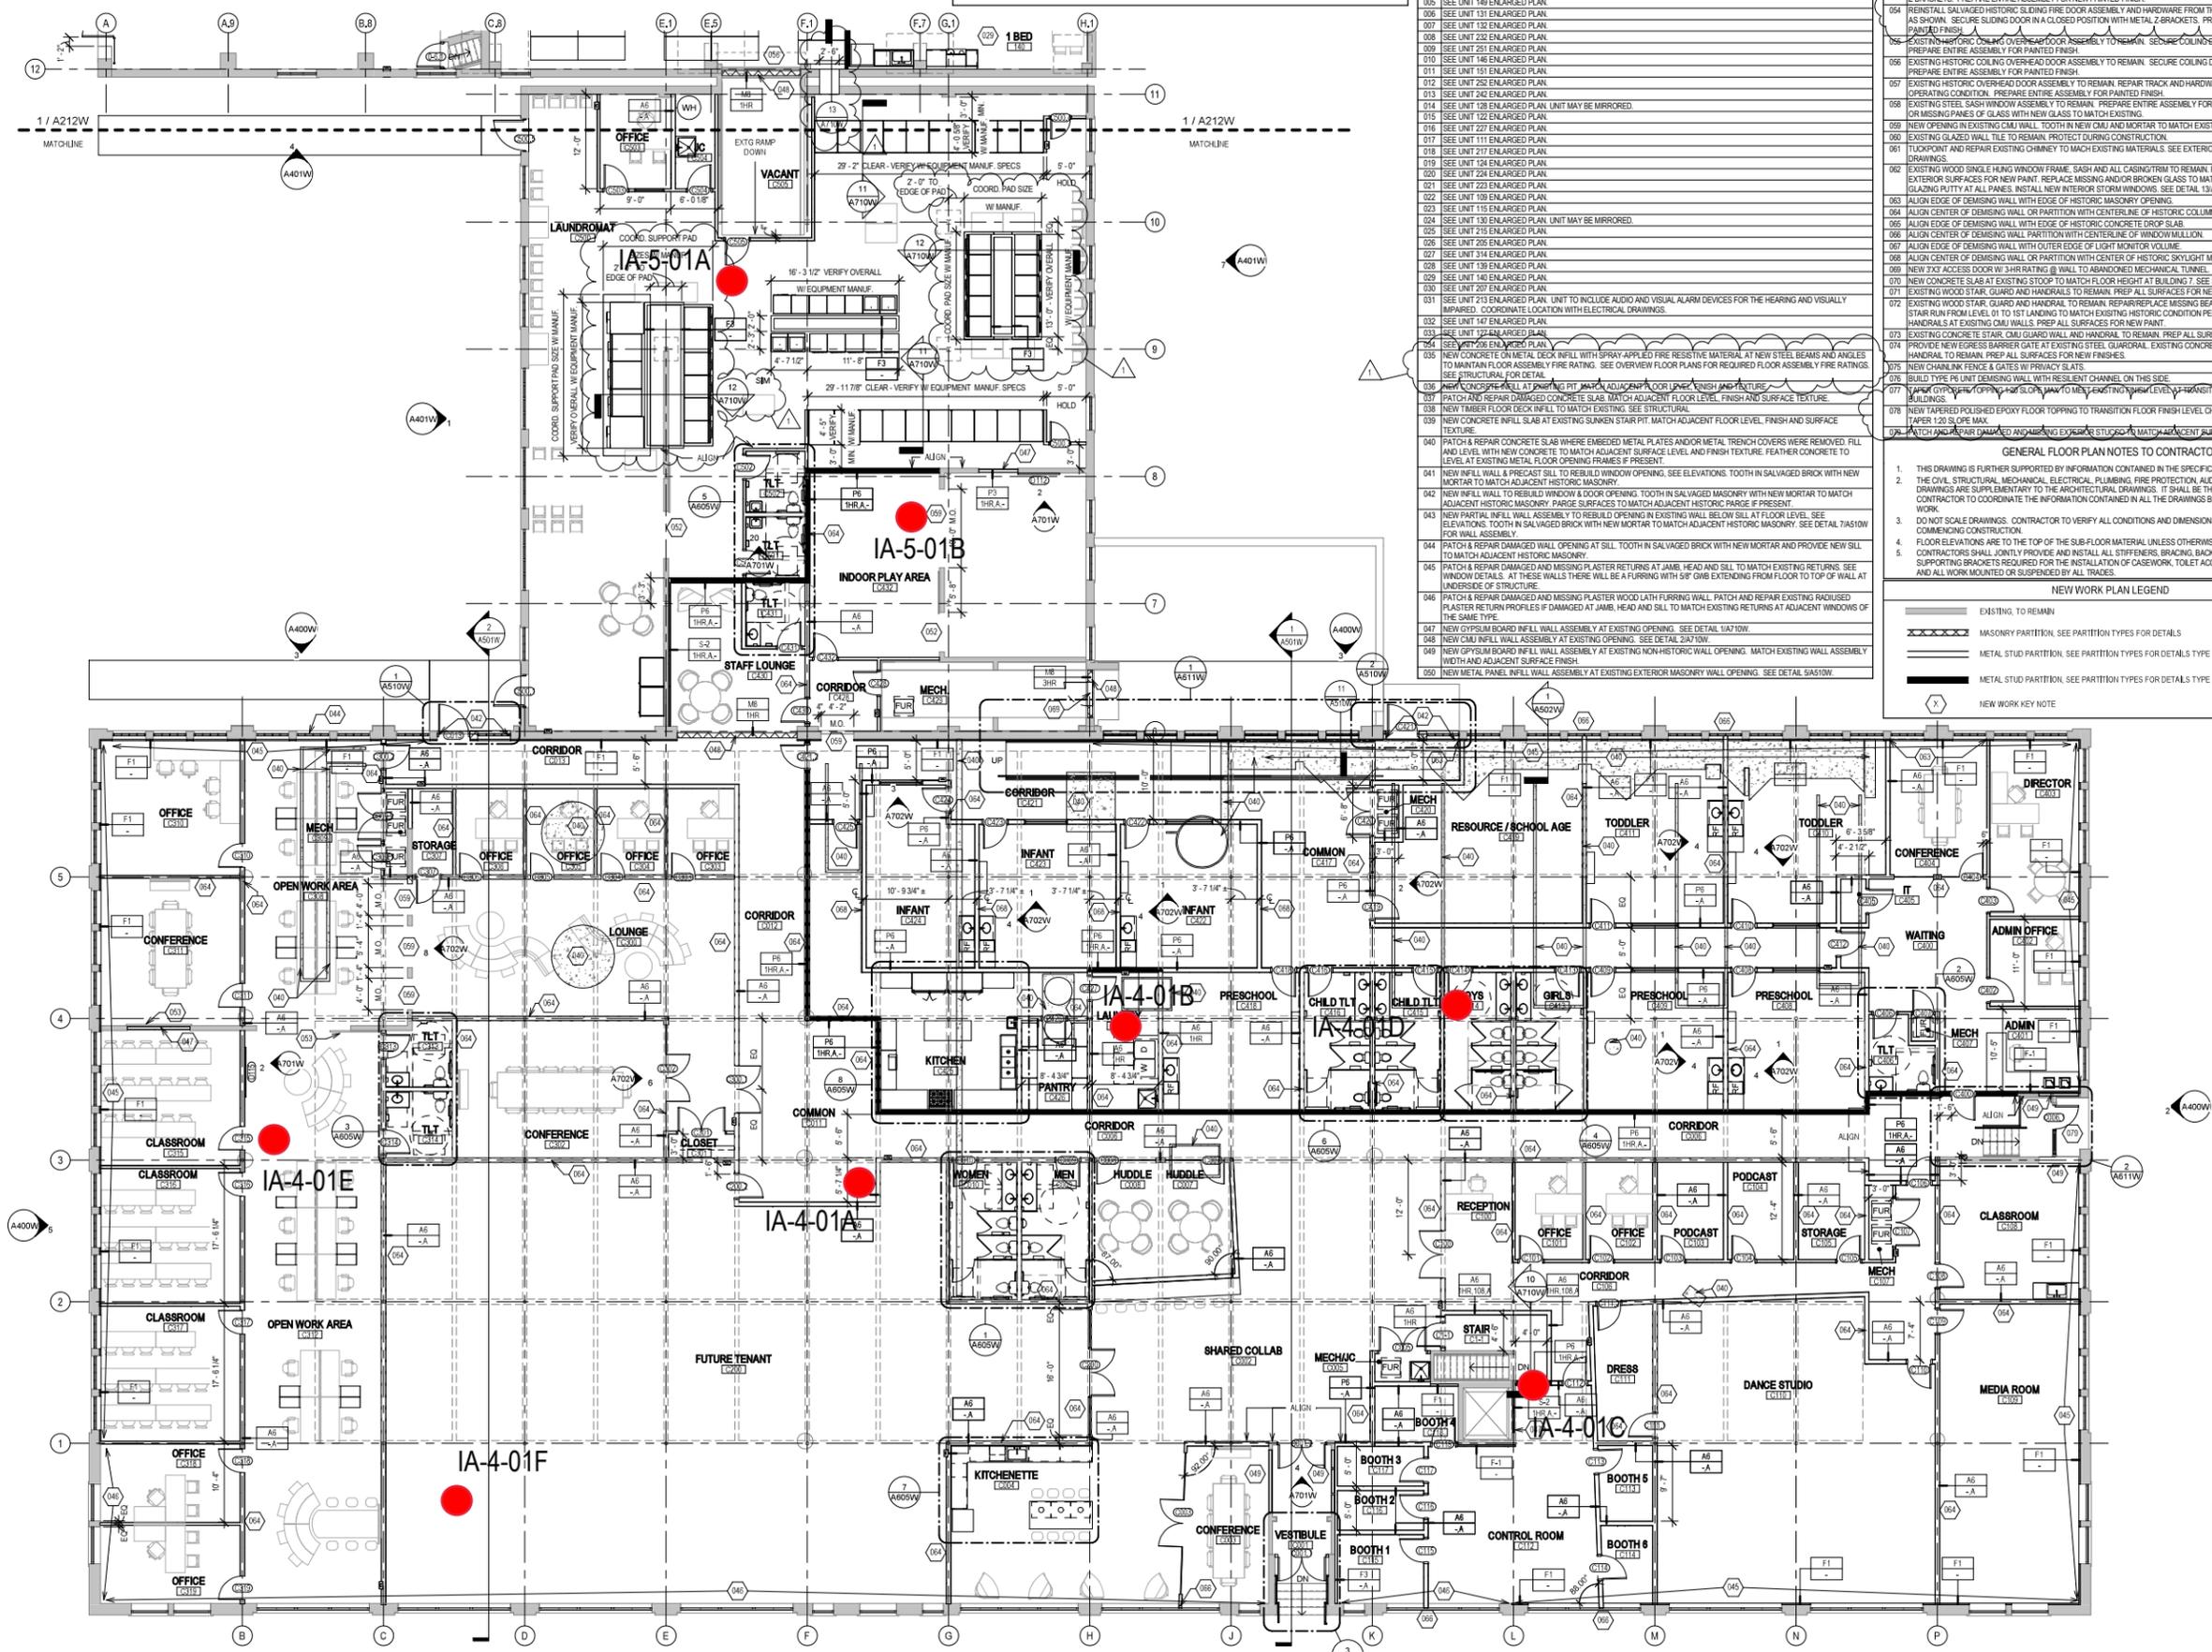


**COMMUNITY WITHIN THE CORRIDOR - WEST BLOCK**

2755 N. 38RD STREET  
MILWAUKEE, WI 53210

SHEET TITLE  
**NEW WORK PLAN - LEVEL 01 - BUILDINGS 4 & 5**

REVISIONS  
1 10/09/20 ADDENDUM #1

SCALE	VARES
PROJECT NUMBER	200102
SET TYPE	CONSTRUCTION DOCUMENTS
DATE ISSUED	9/25/20
SHEET NUMBER	<b>A211W</b>

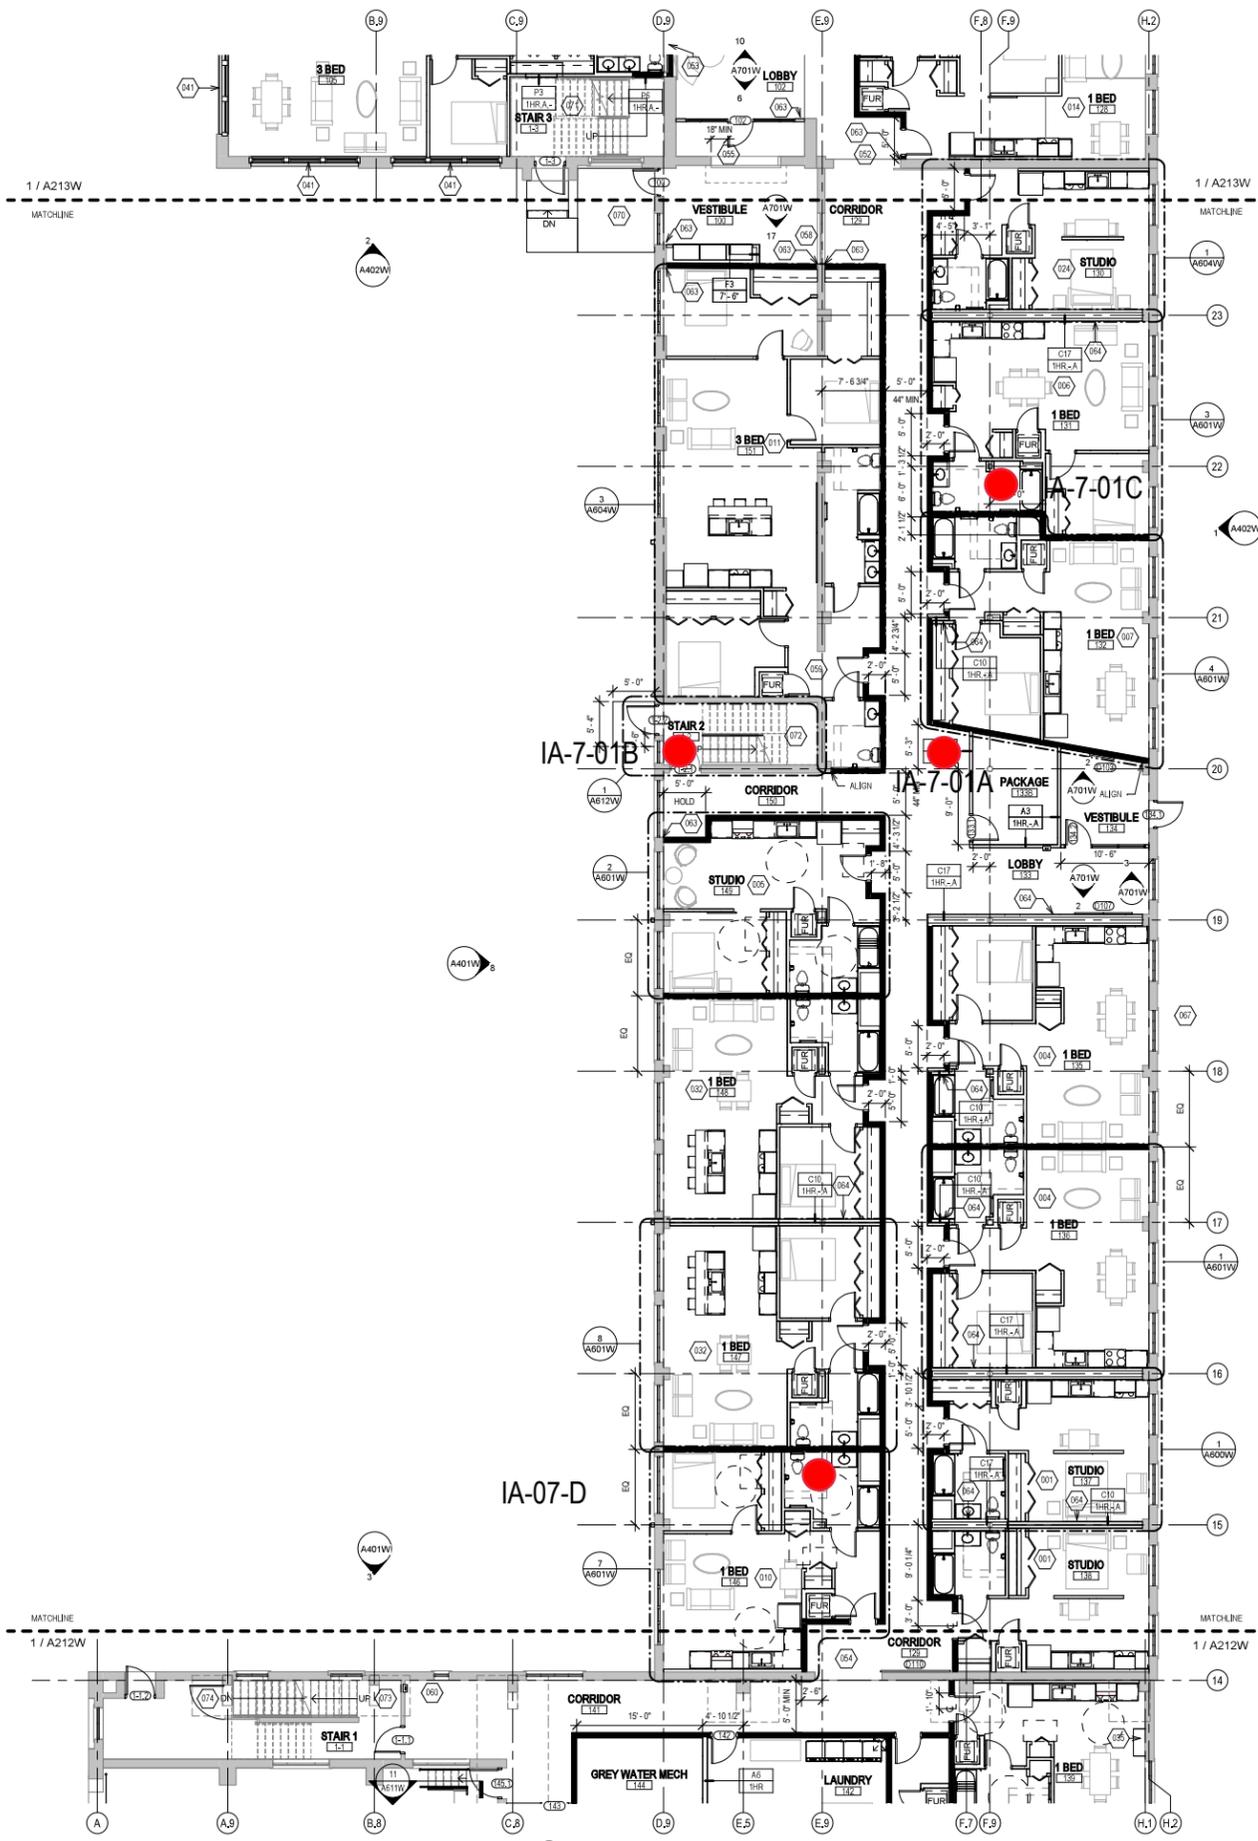

**2 NEW WORK PLAN - LEVEL 01 - BUILDING 7**  
Scale: 1/8" = 1'-0"



**NEW WORK PLAN KEY NOTES - 1/8" PLANS**

- SEE PROJECT GENERAL CONDITIONS, GENERAL INFORMATION ON SHEET A001W AND SELECTIVE DEMOLITION, CUTTING AND PATCHING SPECIFICATIONS THAT ARE USED IN ASSOCIATION WITH THESE NOTES.
- NEW WORK PLAN KEY NOTES APPLY TO ALL 1/8" NEW WORK DRAWINGS AND MAY NOT BE USED ON EVERY SHEET.
- 001 SEE UNIT 137 ENLARGED PLAN.
  - 002 SEE UNIT 105 ENLARGED PLAN.
  - 003 SEE UNIT 115 ENLARGED PLAN.
  - 004 SEE UNIT 18 ENLARGED PLAN. UNIT MAY BE MIRRORRED.
  - 005 SEE UNIT 149 ENLARGED PLAN.
  - 006 SEE UNIT 131 ENLARGED PLAN.
  - 007 SEE UNIT 132 ENLARGED PLAN.
  - 008 SEE UNIT 232 ENLARGED PLAN.
  - 009 SEE UNIT 251 ENLARGED PLAN.
  - 010 SEE UNIT 146 ENLARGED PLAN.
  - 011 SEE UNIT 151 ENLARGED PLAN.
  - 012 SEE UNIT 225 ENLARGED PLAN.
  - 013 SEE UNIT 242 ENLARGED PLAN.
  - 014 SEE UNIT 128 ENLARGED PLAN. UNIT MAY BE MIRRORRED.
  - 015 SEE UNIT 122 ENLARGED PLAN.
  - 016 SEE UNIT 229 ENLARGED PLAN.
  - 017 SEE UNIT 211 ENLARGED PLAN.
  - 018 SEE UNIT 117 ENLARGED PLAN.
  - 019 SEE UNIT 124 ENLARGED PLAN.
  - 020 SEE UNIT 224 ENLARGED PLAN.
  - 021 SEE UNIT 223 ENLARGED PLAN.
  - 022 SEE UNIT 109 ENLARGED PLAN.
  - 023 SEE UNIT 115 ENLARGED PLAN.
  - 024 SEE UNIT 130 ENLARGED PLAN. UNIT MAY BE MIRRORRED.
  - 025 SEE UNIT 215 ENLARGED PLAN.
  - 026 SEE UNIT 205 ENLARGED PLAN.
  - 027 SEE UNIT 314 ENLARGED PLAN.
  - 028 SEE UNIT 139 ENLARGED PLAN.
  - 029 SEE UNIT 140 ENLARGED PLAN.
  - 030 SEE UNIT 207 ENLARGED PLAN.
  - 031 SEE UNIT 213 ENLARGED PLAN. UNIT TO INCLUDE AUDIO AND VISUAL ALARM DEVICES FOR THE HEARING AND VISUALLY IMPAIRED. COORDINATE LOCATION WITH ELECTRICAL DRAWINGS.
  - 032 SEE UNIT 147 ENLARGED PLAN.
  - 033 SEE UNIT 127 ENLARGED PLAN.
  - 034 SEE UNIT 206 ENLARGED PLAN.
  - 035 NEW CONCRETE ON METAL DECK INFILL WITH SPRAY-APPLIED FIRE RESISTIVE MATERIAL AT NEW STEEL BEAMS AND ANGLES TO MAINTAIN FLOOR ASSEMBLY FIRE RATING. SEE OVERVIEW FLOOR PLANS FOR REQUIRED FLOOR ASSEMBLY FIRE RATINGS. SEE STRUCTURAL FOR DETAIL.
  - 036 PATCH AND REPAIR DAMAGED CONCRETE SLAB MATCH ADJACENT FLOOR LEVEL, FINISH AND SURFACE TEXTURE.
  - 037 NEW TIMBER FLOOR DECK INFILL TO MATCH EXISTING. SEE STRUCTURAL.
  - 038 NEW CONCRETE INFILL SLAB AT EXISTING SUNKEN STAIR PIT. MATCH ADJACENT FLOOR LEVEL, FINISH AND SURFACE TEXTURE.
  - 039 PATCH & REPAIR CONCRETE SLAB WHERE EMBEDDED METAL PLATES AND/OR METAL TRENCH COVERS WERE REMOVED. FILL AND LEVEL WITH NEW CONCRETE TO MATCH ADJACENT SURFACE LEVEL AND FINISH TEXTURE. FEATHER CONCRETE TO LEVEL AT EXISTING METAL FLOOR OPENING FRAMES IF PRESENT.
  - 040 NEW INFILL WALL & PRECAST SILL TO REBUILD WINDOW OPENING. SEE ELEVATIONS. TOOTH IN SALVAGED BRICK WITH NEW MORTAR TO MATCH ADJACENT HISTORIC MASONRY.
  - 041 NEW PARTIAL INFILL WALL ASSEMBLY TO REBUILD OPENING IN EXISTING WALL BELOW SILL AT FLOOR LEVEL. SEE ELEVATIONS. TOOTH IN SALVAGED BRICK WITH NEW MORTAR TO MATCH ADJACENT HISTORIC MASONRY. SEE DETAIL 71A51W FOR WALL ASSEMBLY.
  - 042 NEW INFILL WALL TO REBUILD WINDOW & DOOR OPENING. TOOTH IN SALVAGED MASONRY WITH NEW MORTAR TO MATCH ADJACENT HISTORIC MASONRY. PATCH SURFACES TO MATCH ADJACENT HISTORIC FINISH AT PRESENT.
  - 043 NEW PARTIAL INFILL WALL ASSEMBLY TO REBUILD OPENING IN EXISTING WALL BELOW SILL AT FLOOR LEVEL. SEE ELEVATIONS. TOOTH IN SALVAGED BRICK WITH NEW MORTAR TO MATCH ADJACENT HISTORIC MASONRY. SEE DETAIL 71A51W FOR WALL ASSEMBLY.
  - 044 PATCH & REPAIR DAMAGED WALL OPENING AT SILL. TOOTH IN SALVAGED BRICK WITH NEW MORTAR AND PROVIDE NEW SILL TO MATCH ADJACENT HISTORIC MASONRY.
  - 045 PATCH & REPAIR DAMAGED AND MISSING PLASTER RETURNS AT JAMB, HEAD AND SILL TO MATCH EXISTING RETURNS. SEE WINDOW DETAILS. AT THESE WALLS THERE WILL BE A FURRING WITH 5/8" GWS EXTENDING FROM FLOOR TO TOP OF WALL AT UNDERSIDE OF STRUCTURE.
  - 046 PATCH & REPAIR DAMAGED AND MISSING PLASTER RETURNS AT JAMB, HEAD AND SILL TO MATCH EXISTING RETURNS AT ADJACENT WINDOWS OF THE SAME TYPE.
  - 047 NEW GYPSUM BOARD INFILL WALL ASSEMBLY AT EXISTING OPENING. SEE DETAIL 11A10W.
  - 048 NEW CMU INFILL WALL ASSEMBLY AT EXISTING OPENING. SEE DETAIL 2A710W.
  - 049 NEW GYPSUM BOARD INFILL WALL ASSEMBLY AT EXISTING NON-HISTORIC WALL OPENING. MATCH EXISTING WALL ASSEMBLY WIDTH AND ADJACENT SURFACE FINISH.
  - 050 NEW METAL PANEL INFILL WALL ASSEMBLY AT EXISTING EXTERIOR MASONRY WALL OPENING. SEE DETAIL 13A10W.

**NEW WORK PLAN KEY NOTES - 1/8" PLANS**

- SEE PROJECT GENERAL CONDITIONS, GENERAL INFORMATION ON SHEET A001W AND SELECTIVE DEMOLITION, CUTTING AND PATCHING SPECIFICATIONS THAT ARE USED IN ASSOCIATION WITH THESE NOTES.
- NEW WORK PLAN KEY NOTES APPLY TO ALL 1/8" NEW WORK DRAWINGS AND MAY NOT BE USED ON EVERY SHEET.
- 051 NEW METAL PANEL INFILL WALL ASSEMBLY AT EXISTING WINDOW OPENING. SEE DETAIL 13A10W.
  - 052 EXISTING HISTORIC SLIDING FIRE DOOR ASSEMBLY TO REMAIN. SECURE SLIDING DOOR IN A FULLY OPEN POSITION WITH METAL BRACKETS. PREPARE ENTIRE ASSEMBLY FOR PAINTED FINISH.
  - 053 EXISTING HISTORIC SLIDING FIRE DOOR ASSEMBLY TO REMAIN. SECURE SLIDING DOOR IN A CLOSED POSITION WITH METAL Z-BRACKETS. PREPARE ENTIRE ASSEMBLY FOR NEW PAINTED FINISH.
  - 054 REINSTALL SALVAGED HISTORIC SLIDING FIRE DOOR ASSEMBLY AND HARDWARE FROM THE OPENING TO NEW ORIENTATION AS SHOWN. SECURE SLIDING DOOR IN A CLOSED POSITION WITH METAL Z-BRACKETS. PREPARE ENTIRE ASSEMBLY FOR NEW PAINTED FINISH.
  - 055 EXISTING HISTORIC COILING OVERHEAD DOOR ASSEMBLY TO REMAIN. SECURE COILING DOOR IN A FULLY OPEN POSITION. PREPARE ENTIRE ASSEMBLY FOR PAINTED FINISH.
  - 056 EXISTING HISTORIC COILING OVERHEAD DOOR ASSEMBLY TO REMAIN. SECURE COILING DOOR IN A FULLY CLOSED POSITION. PREPARE ENTIRE ASSEMBLY FOR PAINTED FINISH.
  - 057 EXISTING HISTORIC COILING OVERHEAD DOOR ASSEMBLY TO REMAIN. REPAIR TRACK AND HARDWARE TO RETURN DOOR TO OPERATING CONDITION. PREPARE ENTIRE ASSEMBLY FOR PAINTED FINISH.
  - 058 EXISTING STEEL SASH WINDOW ASSEMBLY TO REMAIN. PREPARE ENTIRE ASSEMBLY FOR PAINTED FINISH. REPLACE BROKEN OR MISSING PANE OF GLASS WITH NEW GLASS TO MATCH EXISTING.
  - 059 NEW OPENING IN EXISTING CMU WALL. TOOTH IN NEW CMU AND MORTAR TO MATCH EXISTING.
  - 060 EXISTING GLAZED WALL TILE TO REMAIN. PROTECT DURING CONSTRUCTION.
  - 061 TUCKPOINT AND REPAIR EXISTING CHIMNEY TO MATCH EXISTING MATERIALS. SEE EXTERIOR MASONRY REPORT AND DRAWINGS.
  - 062 EXISTING WOOD SINGLE HUNG WINDOW FRAME, SASH AND ALL CASING/TRIM TO REMAIN. PREPARE EXISTING INTERIOR & EXTERIOR SURFACES FOR NEW PAINT. REPLACE MISSING AND/OR BROKEN GLASS TO MATCH EXISTING AND INSTALL NEW GLAZING PUTTY AT ALL PANELS. INSTALL NEW INTERIOR STORM WINDOWS. SEE DETAIL 13A51W.
  - 063 ALIGN EDGE OF DEMISING WALL WITH EDGE OF HISTORIC MASONRY OPENING.
  - 064 ALIGN CENTER OF DEMISING WALL OR PARTITION WITH CENTERLINE OF HISTORIC COLUMN, OR BEAM ABOVE.
  - 065 ALIGN EDGE OF DEMISING WALL WITH EDGE OF HISTORIC CONCRETE DROP SLAB.
  - 066 ALIGN CENTER OF DEMISING WALL PARTITION WITH CENTERLINE OF WINDOW MULLION.
  - 067 ALIGN EDGE OF DEMISING WALL WITH OUTER EDGE OF LIGHT MONITOR VOLUME.
  - 068 ALIGN CENTER OF DEMISING WALL OR PARTITION WITH CENTER OF HISTORIC SKYLIGHT MULLION ABOVE.
  - 069 NEW 3X3 ACCESS DOOR W/ 3-HR RATING @ WALL TO ABANDONED MECHANICAL TUNNEL.
  - 070 NEW CONCRETE SLAB AT EXISTING STAIR TO MATCH FLOOR HEIGHT AT BUILDING 7. SEE STRUCTURAL.
  - 071 EXISTING WOOD STAIR GUARD AND HANDRAILS TO REMAIN. PREP ALL SURFACES FOR NEW FINISH.
  - 072 EXISTING WOOD STAIR GUARD AND HANDRAIL TO REMAIN. REPAIR/REPLACE MISSING BEAD BOARD HANDRAIL SUPPORT AND STAIR RUN FROM LEVEL 01 TO 1ST LANDING TO MATCH EXISTING HISTORIC CONDITION PERCENT. PROVIDE NEW STEEL HANDRAILS AT EXISTING CMU WALLS. PREP ALL SURFACES FOR NEW PAINT.
  - 073 EXISTING CONCRETE STAIR, CMU GUARD WALL AND HANDRAIL TO REMAIN. PREP ALL SURFACES FOR NEW FINISHES.
  - 074 PROVIDE NEW EGRESS BARRIER GATE AT EXISTING STEEL GUARDRAIL. EXISTING CONCRETE STAIR, STEEL GUARDRAIL AND HANDRAIL TO REMAIN. PREP ALL SURFACES FOR NEW FINISHES.
  - 075 NEW CHIMNEY BRICK INFILL WALL ASSEMBLY AT EXISTING OPENING. SEE DETAIL 13A10W.
  - 076 BUILD TYPE 2 UNIT DEMISING WALL WITH RESILIENT CHANNEL ON THIS SIDE.
  - 077 TAPER SPORE TOPPING TO SLOPE MAX TO MEET EXISTING FINISH LEVEL AT TRANSITION AREA TO STAIRS OF BETWEEN BUILDINGS.
  - 078 NEW TAPERED POLISHED EPOXY FLOOR TOPPING TO TRANSITION FLOOR FINISH LEVEL CHANGE BETWEEN BUILDINGS 6 & 7. TAPER 1:20 SLOPE MAX.
  - 079 PATCH AND REPAIR DAMAGED AND MISSING EXTERIOR STUCCO TO MATCH ADJACENT SURFACE.

- GENERAL FLOOR PLAN NOTES TO CONTRACTOR**
- THIS DRAWING IS FURTHER SUPPORTED BY INFORMATION CONTAINED IN THE SPECIFICATION MANUAL.
  - THE CIVIL, STRUCTURAL, MECHANICAL, ELECTRICAL, PLUMBING, FIRE PROTECTION, AUDIO-VISUAL, AND SECURITY DRAWINGS ARE SUPPLEMENTARY TO THE ARCHITECTURAL DRAWINGS. IT SHALL BE THE RESPONSIBILITY OF THE CONTRACTOR TO COORDINATE THE INFORMATION CONTAINED IN ALL THE DRAWINGS BEFORE THE INSTALLATION OF ALL WORK.
  - DO NOT SCALE DRAWINGS. CONTRACTOR TO VERIFY ALL CONDITIONS AND DIMENSIONS AT THE JOB SITE PRIOR TO COMMENCING CONSTRUCTION.
  - FLOOR ELEVATIONS ARE TO THE TOP OF THE SUB-FLOOR MATERIAL UNLESS OTHERWISE NOTED.
  - CONTRACTORS SHALL JOINTLY PROVIDE AND INSTALL ALL STIFFENERS, BRACING, BACKING PLATES, WALL BRACING AND SUPPORTING BRACKETS REQUIRED FOR THE INSTALLATION OF CASEWORK, TOILET ACCESSORIES, PARTITIONS, MILLWORK, AND ALL WORK MOUNTED OR SUSPENDED BY ALL TRACES.

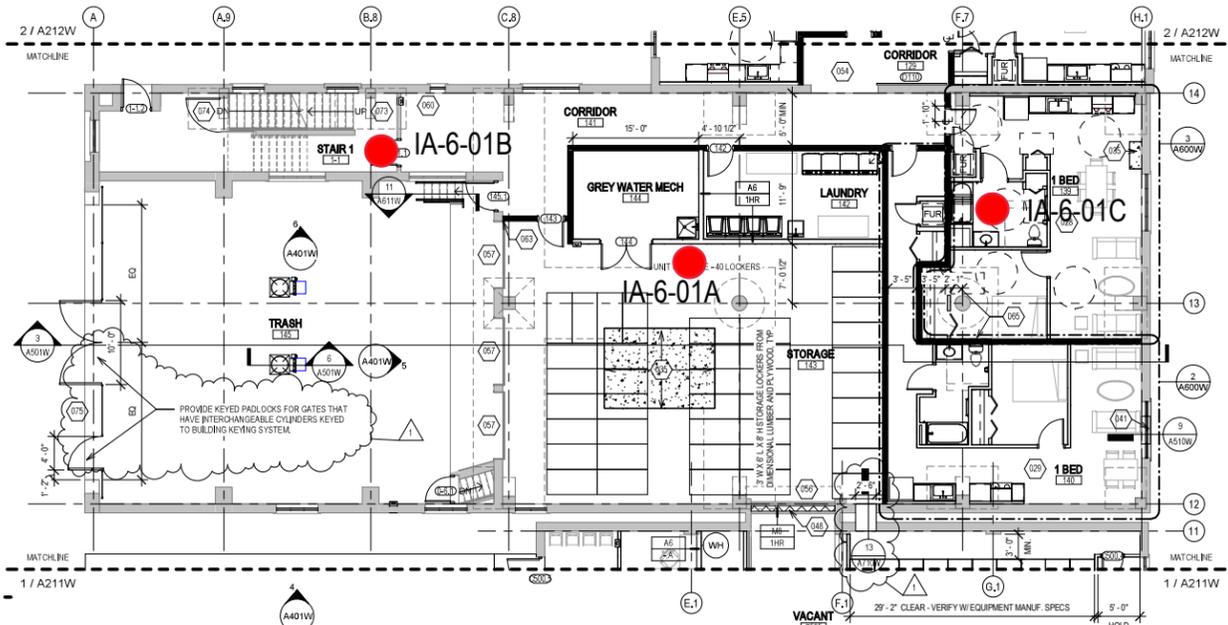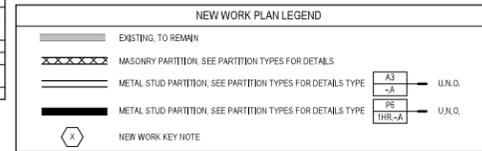

**1 NEW WORK PLAN - LEVEL 01 - BUILDING 6**  
Scale: 1/8" = 1'-0"

T 414.220.9640  
751 N Jefferson St.  
Suite 200  
Milwaukee, WI 53202

CONSULTANTS

COMMUNITY WITHIN THE CORRIDOR - WEST BLOCK

755 N. 33RD STREET  
MILWAUKEE, WI 53210

SHEET TITLE: **NEW WORK PLAN - LEVEL 01 - BUILDINGS 6 & 7**

REVISIONS  
**1 10/09/20 ADDENDUM #1**

SCALE VARIES


PROJECT NUMBER 200102

SET TYPE **CONSTRUCTION DOCUMENTS**

DATE ISSUED **9/25/20**

SHEET NUMBER **A212W**

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**NEW WORK PLAN KEY NOTES - 1/8" PLANS**

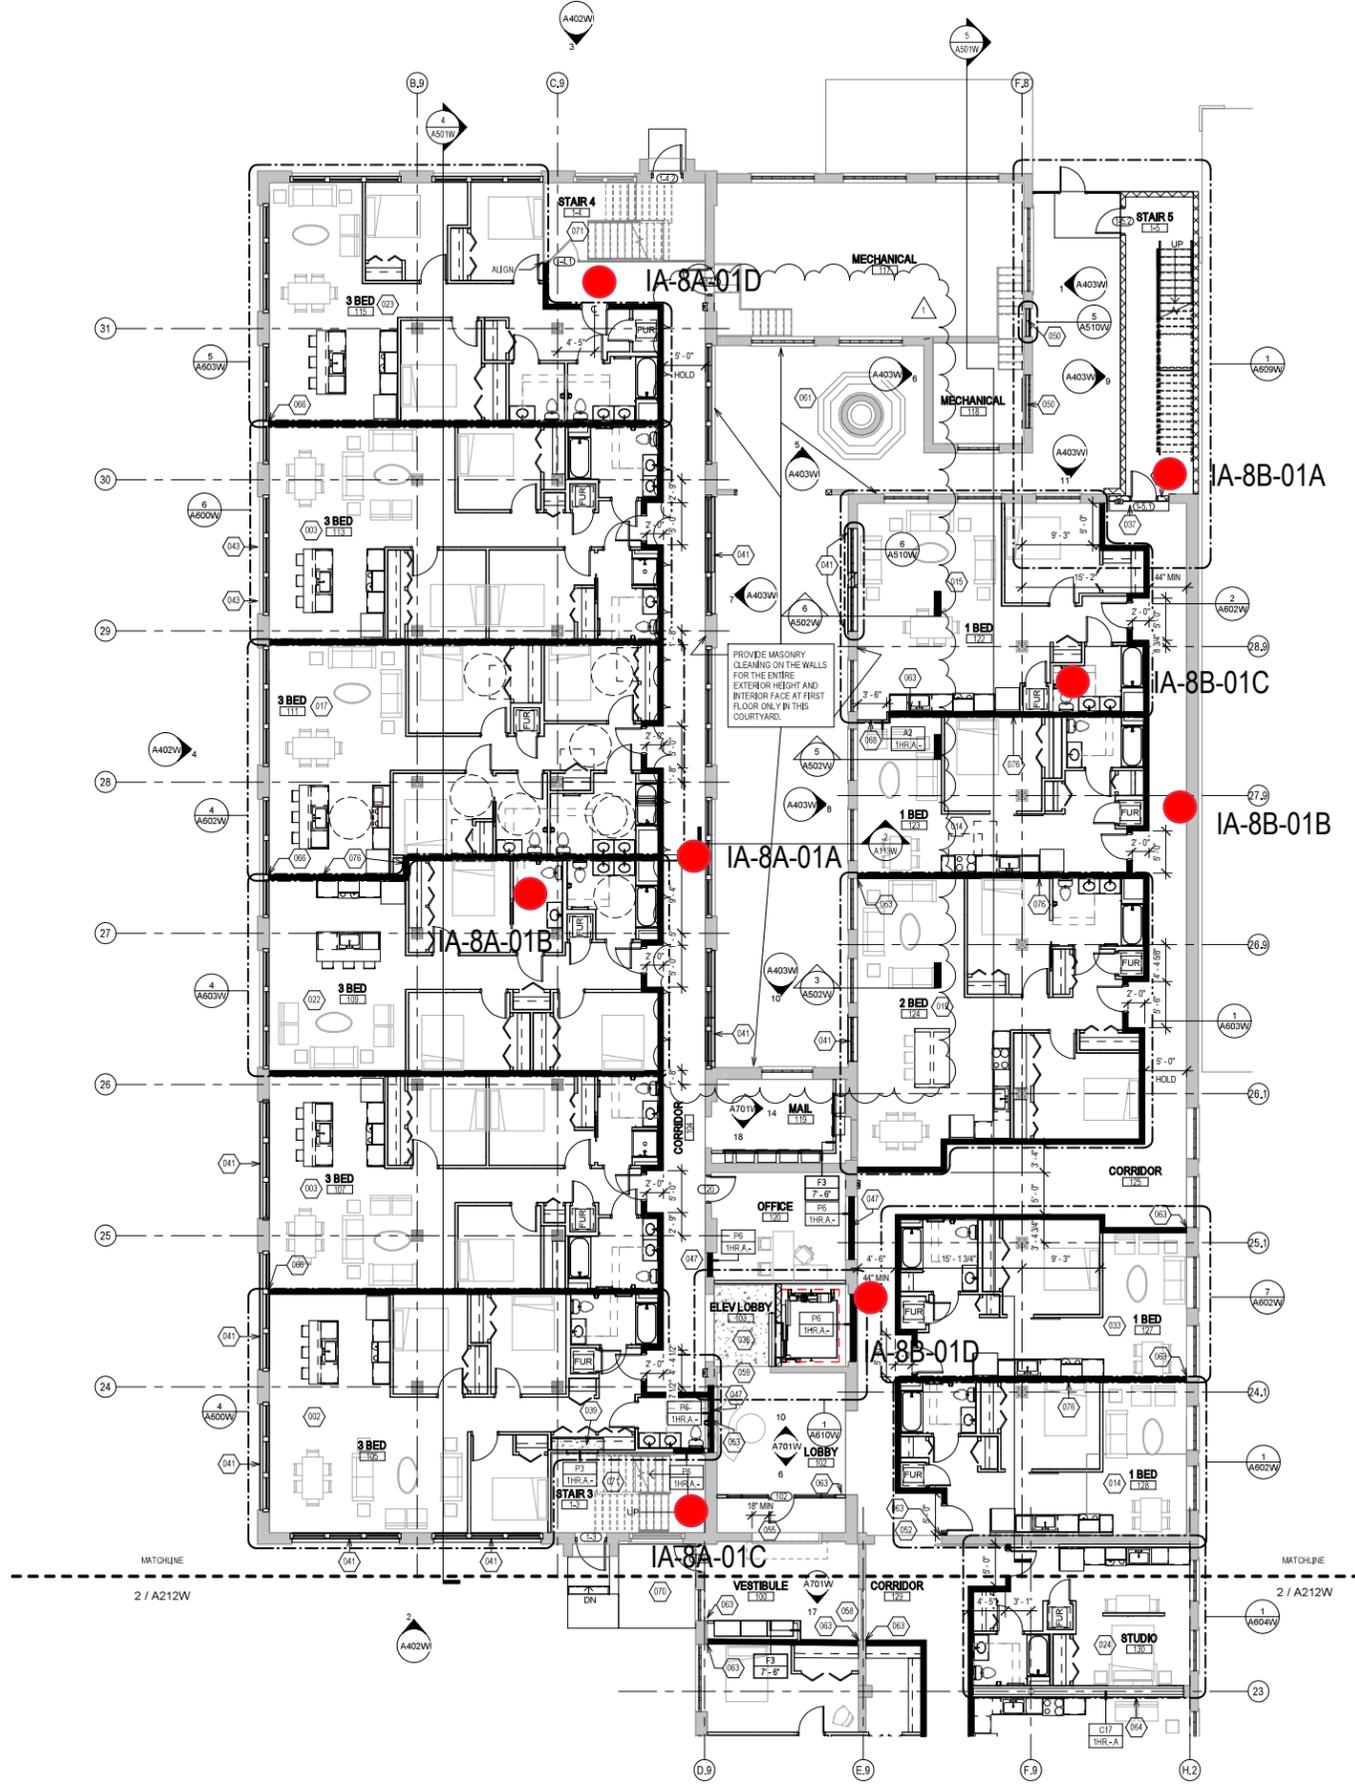- SEE PROJECT GENERAL CONDITIONS, GENERAL INFORMATION ON SHEET A001W AND SELECTIVE DEMOLITION, CUTTING AND PATCHING SPECIFICATIONS THAT ARE USED IN ASSOCIATION WITH THESE NOTES.
- NEW WORK PLAN KEY NOTES APPLY TO ALL 1/8" NEW WORK DRAWINGS AND MAY NOT BE USED ON EVERY SHEET.
- 001 SEE UNIT 137 ENLARGED PLAN.
  - 002 SEE UNIT 105 ENLARGED PLAN.
  - 003 SEE UNIT 113 ENLARGED PLAN.
  - 004 SEE UNIT 118 ENLARGED PLAN. UNIT MAY BE MIRRORED.
  - 005 SEE UNIT 149 ENLARGED PLAN.
  - 006 SEE UNIT 131 ENLARGED PLAN.
  - 007 SEE UNIT 132 ENLARGED PLAN.
  - 008 SEE UNIT 232 ENLARGED PLAN.
  - 009 SEE UNIT 251 ENLARGED PLAN.
  - 010 SEE UNIT 148 ENLARGED PLAN.
  - 011 SEE UNIT 151 ENLARGED PLAN.
  - 012 SEE UNIT 225 ENLARGED PLAN.
  - 013 SEE UNIT 242 ENLARGED PLAN.
  - 014 SEE UNIT 128 ENLARGED PLAN. UNIT MAY BE MIRRORED.
  - 015 SEE UNIT 122 ENLARGED PLAN.
  - 016 SEE UNIT 221 ENLARGED PLAN.
  - 017 SEE UNIT 111 ENLARGED PLAN.
  - 018 SEE UNIT 217 ENLARGED PLAN.
  - 019 SEE UNIT 124 ENLARGED PLAN.
  - 020 SEE UNIT 224 ENLARGED PLAN.
  - 021 SEE UNIT 223 ENLARGED PLAN.
  - 022 SEE UNIT 109 ENLARGED PLAN.
  - 023 SEE UNIT 115 ENLARGED PLAN.
  - 024 SEE UNIT 133 ENLARGED PLAN. UNIT MAY BE MIRRORED.
  - 025 SEE UNIT 215 ENLARGED PLAN.
  - 026 SEE UNIT 205 ENLARGED PLAN.
  - 027 SEE UNIT 314 ENLARGED PLAN.
  - 028 SEE UNIT 139 ENLARGED PLAN.
  - 029 SEE UNIT 140 ENLARGED PLAN.
  - 030 SEE UNIT 207 ENLARGED PLAN.
  - 031 SEE UNIT 213 ENLARGED PLAN. UNIT TO INCLUDE AUDIO AND VISUAL ALARM DEVICES FOR THE HEARING AND VISUALLY IMPAIRED. COORDINATE LOCATION WITH ELECTRICAL DRAWINGS.
  - 032 SEE UNIT 143 ENLARGED PLAN.
  - 033 SEE UNIT 127 ENLARGED PLAN.
  - 034 SEE UNIT 206 ENLARGED PLAN.
  - 035 NEW CONCRETE ON METAL DECK INFILL WITH SPRAY-APPLIED FIRE RESISTIVE MATERIAL AT NEW STEEL BEAMS AND ANGLES TO MAINTAIN FLOOR ASSEMBLY FIRE RATING. SEE OVERVIEW FLOOR PLANS FOR REQUIRED FLOOR ASSEMBLY FIRE RATINGS. SEE STRUCTURAL FOR DETAIL.
  - 036 NEW CONCRETE INFILL AT EXISTING PIT MATCH ADJACENT FLOOR LEVEL, FINISH AND SURFACE TEXTURE.
  - 037 PATCH AND REPAIR DAMAGED CONCRETE SLAB MATCH ADJACENT FLOOR LEVEL, FINISH AND SURFACE TEXTURE.
  - 038 NEW TIMBER FLOOR DECK INFILL TO MATCH EXISTING. SEE STRUCTURAL.
  - 039 NEW CONCRETE INFILL SLAB AT EXISTING SUNKEN STAIR PIT MATCH ADJACENT FLOOR LEVEL, FINISH AND SURFACE TEXTURE.
  - 040 PATCH & REPAIR CONCRETE SLAB WHERE EMBEDDED METAL PLATES AND/OR METAL TRENCH COVERS WERE REMOVED. FILL AND LEVEL WITH NEW CONCRETE TO MATCH ADJACENT SURFACE LEVEL AND FINISH TEXTURE. FEATHER CONCRETE TO LEVEL AT EXISTING METAL FLOOR OPENING FRAMES IF PRESENT.
  - 041 NEW INFILL WALL & PRECAST SILL TO REBUILD WINDOW OPENING. SEE ELEVATIONS. TOOTH IN SALVAGED BRICK WITH NEW MORTAR TO MATCH ADJACENT HISTORIC MASONRY.
  - 042 NEW INFILL WALL TO REBUILD WINDOW & DOOR OPENING. TOOTH IN SALVAGED MASONRY WITH NEW MORTAR TO MATCH ADJACENT HISTORIC MASONRY. PARGE SURFACES TO MATCH ADJACENT HISTORIC PARGE IF PRESENT.
  - 043 NEW PARTIAL INFILL WALL ASSEMBLY TO REBUILD OPENING IN EXISTING WALL BELOW SILL AT FLOOR LEVEL. SEE ELEVATIONS. TOOTH IN SALVAGED BRICK WITH NEW MORTAR TO MATCH ADJACENT HISTORIC MASONRY. SEE DETAIL 71A51W FOR WALL ASSEMBLY.
  - 044 PATCH & REPAIR DAMAGED WALL OPENING AT SILL. TOOTH IN SALVAGED BRICK WITH NEW MORTAR AND PROVIDE NEW SILL TO MATCH ADJACENT HISTORIC MASONRY.
  - 045 PATCH & REPAIR DAMAGED AND MISSING PLASTER RETURNS AT JAMB, HEAD AND SILL TO MATCH EXISTING RETURNS. SEE WINDOW DETAILS. AT THESE WALLS THERE WILL BE A FURRING WITH 3/8" GWB EXTENDING FROM FLOOR TO TOP OF WALL AT UNDERSIDE OF STRUCTURE.
  - 046 PATCH & REPAIR DAMAGED AND MISSING PLASTER WOOD LATH FURRING WALL. PATCH AND REPAIR EXISTING RADICUSED PLASTER RETURN PROFILES IF DAMAGED AT JAMB, HEAD AND SILL TO MATCH EXISTING RETURNS AT ADJACENT WINDOWS OF THE SAME TYPE.
  - 047 NEW GYPSUM BOARD INFILL WALL ASSEMBLY AT EXISTING OPENING. SEE DETAIL 11A10W.
  - 048 NEW CMU INFILL WALL ASSEMBLY AT EXISTING OPENING. SEE DETAIL Z1710W.
  - 049 NEW GYPSUM BOARD INFILL WALL ASSEMBLY AT EXISTING NON-HISTORIC WALL OPENING. MATCH EXISTING WALL ASSEMBLY WIDTH AND ADJACENT SURFACE FINISH.
  - 050 NEW METAL PANEL INFILL WALL ASSEMBLY AT EXISTING EXTERIOR MASONRY WALL OPENING. SEE DETAIL S4S10W.

**NEW WORK PLAN KEY NOTES - 1/8" PLANS**

- SEE PROJECT GENERAL CONDITIONS, GENERAL INFORMATION ON SHEET A001W AND SELECTIVE DEMOLITION, CUTTING AND PATCHING SPECIFICATIONS THAT ARE USED IN ASSOCIATION WITH THESE NOTES.
- NEW WORK PLAN KEY NOTES APPLY TO ALL 1/8" NEW WORK DRAWINGS AND MAY NOT BE USED ON EVERY SHEET.
- 051 NEW METAL PANEL INFILL WALL ASSEMBLY AT EXISTING WINDOW OPENING. SEE DETAIL Z1710W.
  - 052 EXISTING HISTORIC SLIDING FIRE DOOR ASSEMBLY TO REMAIN. SECURE SLIDING DOOR IN A FULLY OPEN POSITION WITH METAL Z-BRACKETS. PREPARE ENTIRE ASSEMBLY FOR PAINTED FINISH.
  - 053 EXISTING HISTORIC SLIDING FIRE DOOR ASSEMBLY TO REMAIN. SECURE SLIDING DOOR IN A CLOSED POSITION WITH METAL Z-BRACKETS. PREPARE ENTIRE ASSEMBLY FOR NEW PAINTED FINISH.
  - 054 REINFORCE SALVAGED HISTORIC SLIDING FIRE DOOR ASSEMBLY AND HARDWARE FROM THIS OPENING TO NEW ORIENTATION AS SHOWN. SECURE SLIDING DOOR IN A CLOSED POSITION WITH METAL Z-BRACKETS. PREPARE ENTIRE ASSEMBLY FOR NEW PAINTED FINISH.
  - 055 EXISTING HISTORIC COILING OVERHEAD DOOR ASSEMBLY TO REMAIN. SECURE COILING DOOR IN A FULLY OPEN POSITION. PREPARE ENTIRE ASSEMBLY FOR PAINTED FINISH.
  - 056 EXISTING HISTORIC COILING OVERHEAD DOOR ASSEMBLY TO REMAIN. SECURE COILING DOOR IN A FULLY CLOSED POSITION. PREPARE ENTIRE ASSEMBLY FOR PAINTED FINISH.
  - 057 EXISTING HISTORIC OVERHEAD DOOR ASSEMBLY TO REMAIN. REPAIR TRACK AND HARDWARE TO RETURN DOOR TO OPERATING CONDITION. PREPARE ENTIRE ASSEMBLY FOR PAINTED FINISH.
  - 058 EXISTING STEEL SASH WINDOW ASSEMBLY TO REMAIN. PREPARE ENTIRE ASSEMBLY FOR PAINTED FINISH. REPLACE BROKEN OR MISSING PANE OF GLASS WITH NEW GLASS TO MATCH EXISTING.
  - 059 NEW OPENING IN EXISTING CMU WALL. TOOTH IN NEW CMU AND MORTAR TO MATCH EXISTING.
  - 060 EXISTING GLAZED WALL TILE TO REMAIN. PROTECT DURING CONSTRUCTION.
  - 061 TUCKPOINT AND REPAIR EXISTING CHIMNEY TO MATCH EXISTING MATERIALS. SEE EXTERIOR MASONRY REPORT AND DRAWINGS.
  - 062 EXISTING WOOD SINGLE HUNG WINDOW FRAME, SASH AND ALL CASING/TRIM TO REMAIN. PREPARE EXISTING INTERIOR & EXTERIOR SURFACES FOR NEW PAINT. REPLACE MISSING AND/OR BROKEN GLASS TO MATCH EXISTING AND INSTALL NEW GLAZING PANE OF GLASS WITH NEW GLASS TO MATCH EXISTING.
  - 063 ALIGN EDGE OF DEMISING WALL WITH EDGE OF HISTORIC MASONRY OPENING.
  - 064 ALIGN CENTER OF DEMISING WALL OR PARTITION WITH CENTERLINE OF HISTORIC COLUMN, OR BEAM ABOVE.
  - 065 ALIGN EDGE OF DEMISING WALL WITH EDGE OF HISTORIC CONCRETE DROP SLAB.
  - 066 ALIGN CENTER OF DEMISING WALL PARTITION WITH CENTERLINE OF WINDOW MULLION.
  - 067 ALIGN EDGE OF DEMISING WALL WITH OUTER EDGE OF LIGHT MONITOR COLUMN.
  - 068 ALIGN CENTER OF DEMISING WALL OR PARTITION WITH CENTER OF HISTORIC SKYLIGHT MULLION ABOVE.
  - 069 NEW 3X3 ACCESS DOOR W/ 3-HR RATING @ WALL TO ABANDONED MECHANICAL TUNNEL.
  - 070 NEW CONCRETE SLAB AT EXISTING STOOP TO MATCH FLOOR HEIGHT AT BUILDING 7. SEE STRUCTURAL.
  - 071 EXISTING WOOD STAIR, GUARD AND HANDRAIL TO REMAIN. REPAIR/REPLACE MISSING BEAD BOARD HANDRAIL SUPPORT AND STAIR RUN FROM LEVEL 01 TO 1ST LANDING TO MATCH EXISTING HISTORIC CONDITION PERCENT. PROVIDE NEW STEEL HANDRAILS AT EXISTING CMU WALLS. PREP ALL SURFACES FOR NEW PAINT.
  - 072 EXISTING WOOD STAIR, GUARD AND HANDRAIL TO REMAIN. REPAIR/REPLACE MISSING BEAD BOARD HANDRAIL SUPPORT AND STAIR RUN FROM LEVEL 01 TO 1ST LANDING TO MATCH EXISTING HISTORIC CONDITION PERCENT. PROVIDE NEW STEEL HANDRAILS AT EXISTING CMU WALLS. PREP ALL SURFACES FOR NEW PAINT.
  - 073 EXISTING CONCRETE STAIR, CMU GUARD WALL AND HANDRAIL TO REMAIN. PREP ALL SURFACES FOR NEW FINISHES.
  - 074 PROVIDE NEW EGRESS BARRIER GATE AT EXISTING STEEL GUARDRAIL. EXISTING CONCRETE STAIR, STEEL GUARDRAIL AND HANDRAIL TO REMAIN. PREP ALL SURFACES FOR NEW FINISHES.
  - 075 NEW CHAINLINK FENCE, GATES AND HANDRAILS TO REMAIN. PREP ALL SURFACES FOR NEW PAINT.
  - 076 BUILD TYPE P6 UNIT DEMISING WALL WITH RESILIENT CHANNEL ON THIS SIDE.
  - 077 TAPER CONCRETE TOPPING 1:20 SLOPE MAX TO MEET EXISTING FINISH LEVEL AT TRANSITION AREA TO STAIRS OR BETWEEN BUILDINGS.
  - 078 NEW TAPERED POLISHED EPOXY FLOOR TOPPING TO TRANSITION FLOOR FINISH LEVEL CHANGE BETWEEN BUILDINGS 6 & 7. TAPER 1:20 SLOPE MAX.
  - 079 PATCH AND REPAIR DAMAGED AND MISSING EXTERIOR STUCCO TO MATCH ADJACENT SURFACE.

- GENERAL FLOOR PLAN NOTES TO CONTRACTOR**
1. THIS DRAWING IS FURTHER SUPPORTED BY INFORMATION CONTAINED IN THE SPECIFICATION MANUAL.
  2. THE CIVIL, STRUCTURAL, MECHANICAL, ELECTRICAL, PLUMBING, FIRE PROTECTION, AUDIO-VISUAL, AND SECURITY DRAWINGS ARE SUPPLEMENTARY TO THE ARCHITECTURAL DRAWINGS. IT SHALL BE THE RESPONSIBILITY OF THE CONTRACTOR TO COORDINATE THE INFORMATION CONTAINED IN ALL THE DRAWINGS BEFORE THE INSTALLATION OF ALL WORK.
  3. DO NOT SCALE DRAWINGS. CONTRACTOR TO VERIFY ALL CONDITIONS AND DIMENSIONS AT THE JOB SITE PRIOR TO COMMENCING CONSTRUCTION.
  4. FLOOR ELEVATIONS ARE TO THE TOP OF THE SUB-FLOOR MATERIAL UNLESS OTHERWISE NOTED.
  5. CONTRACTORS SHALL JOINTLY PROVIDE AND INSTALL ALL STIFFENERS, BRACING, BACKING PLATES, WALL BLOCKING AND SUPPORTING BRACKETS REQUIRED FOR THE INSTALLATION OF CASEWORK, TOILET ACCESSORIES, PARTITIONS, MILLWORK, AND ALL WORK MOUNTED OR SUSPENDED BY ALL TRACES.

**NEW WORK PLAN LEGEND**

	EXISTING TO REMAIN		
	MASONRY PARTITION. SEE PARTITION TYPES FOR DETAILS		U.N.O.
	METAL STUD PARTITION. SEE PARTITION TYPES FOR DETAILS TYPE		U.N.O.
	METAL STUD PARTITION. SEE PARTITION TYPES FOR DETAILS TYPE		U.N.O.
	NEW WORK KEY NOTE		

**PATCH AND INFILL LEGEND**

	CONCRETE FLOOR OPENING INFILL. SEE STRUCTURAL FOR INFILL CONDITIONS. V.I.F. EXACT SIZE AND LOCATIONS.
	CONCRETE FLOOR COSMETIC PATCH. V.I.F. EXACT SIZE AND LOCATIONS.
	WOOD FLOOR STRUCTURAL INFILL. SEE STRUCTURAL FOR INFILL CONDITIONS. V.I.F. EXACT SIZE AND LOCATIONS.

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Suite 200  
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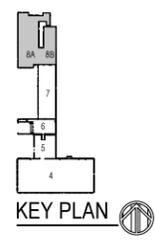
CONSULTANTS

COMMUNITY WITHIN THE CORRIDOR - WEST BLOCK  
2758 N. 38RD STREET  
MILWAUKEE, WI 53210  
SHEET TITLE  
NEW WORK PLAN - LEVEL 01 - BUILDING 8A & 8B


REVISIONS  
1 10/09/20 ADDENDUM #1

SCALE	VARES
PROJECT NUMBER	200102
SET TYPE	CONSTRUCTION DOCUMENTS
DATE ISSUED	9/25/20
SHEET NUMBER	A213W

**1 NEW WORK PLAN - LEVEL 01 - BUILDING 8A & 8B**  
Scale: 1/8" = 1'-0"  
0 2 4 8 12



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1 NEW WORK PLAN - LEVEL 02 - OVERVIEW  
Scale: 3/64" = 1'-0"

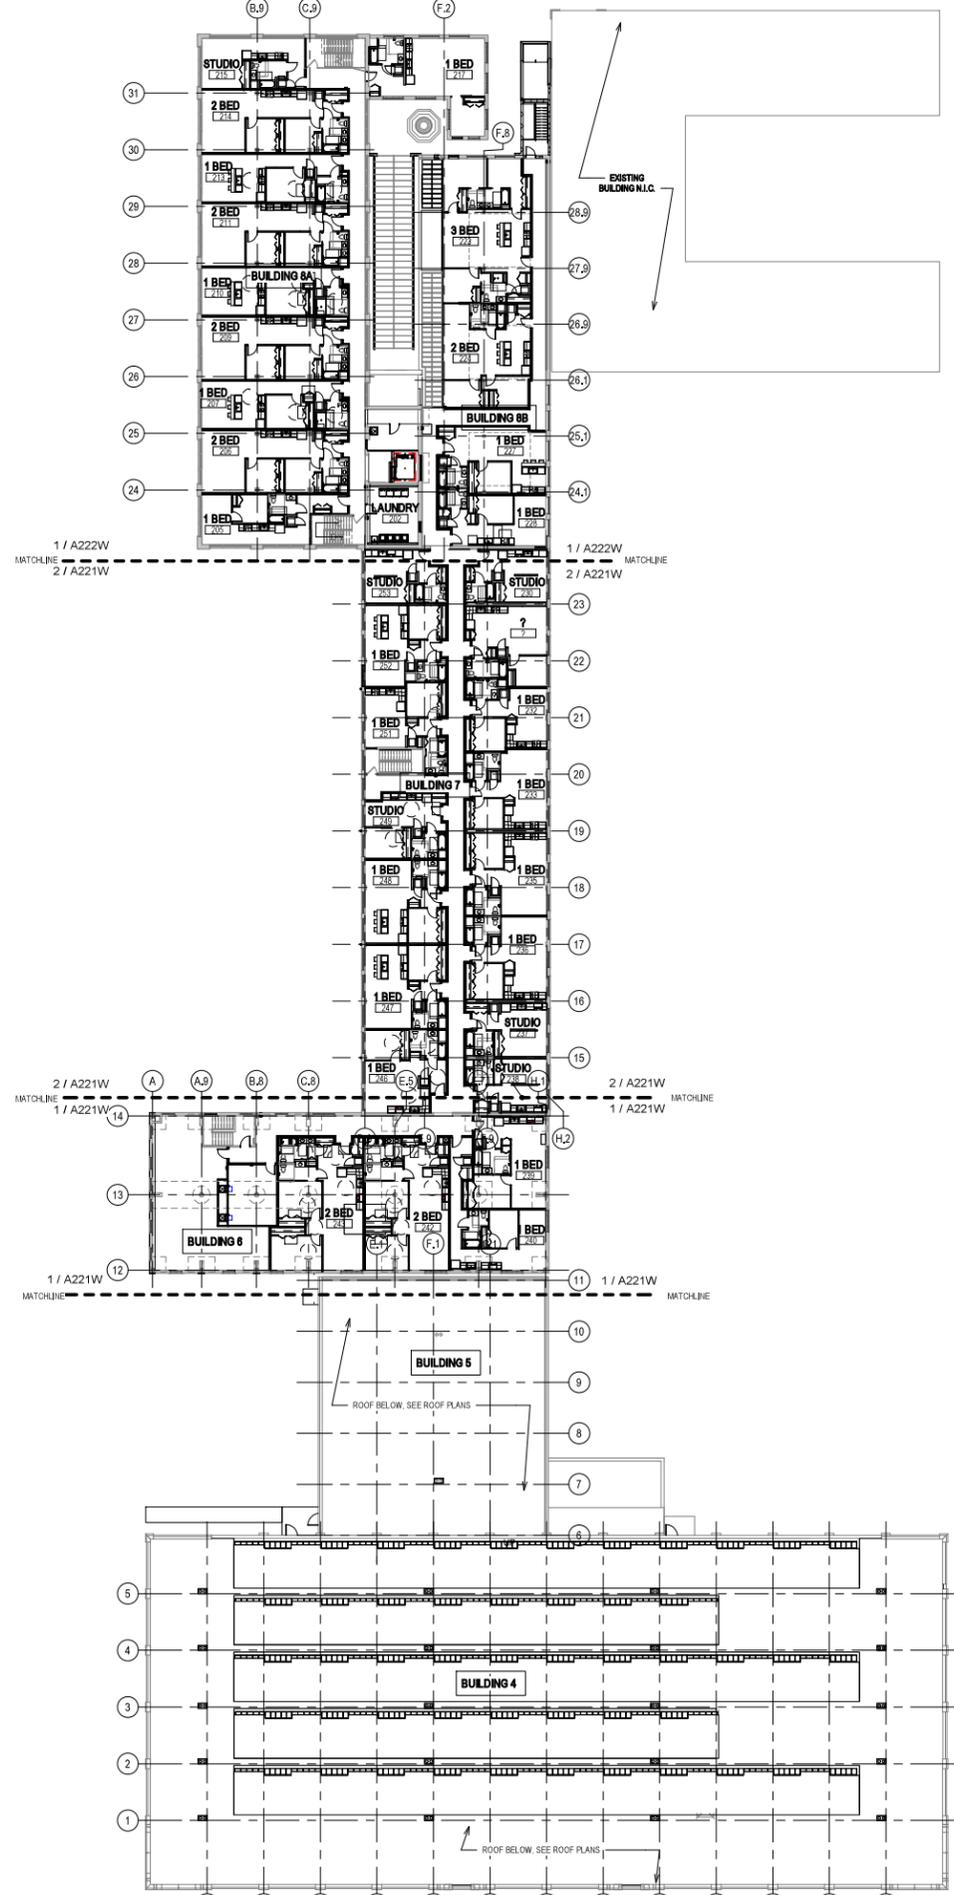
NEW WORK PLAN KEY NOTES - 1/8" PLANS

- SEE PROJECT GENERAL CONDITIONS, GENERAL INFORMATION ON SHEET A010W AND SELECTIVE DEMOLITION, CUTTING AND PATCHING SPECIFICATIONS THAT ARE USED IN ASSOCIATION WITH THESE NOTES.
- NEW WORK PLAN KEY NOTES APPLY TO ALL 1/8" NEW WORK DRAWINGS AND MAY NOT BE USED ON EVERY SHEET.
- 001 SEE UNIT 137 ENLARGED PLAN.
  - 002 SEE UNIT 105 ENLARGED PLAN.
  - 003 SEE UNIT 113 ENLARGED PLAN.
  - 004 SEE UNIT 138 ENLARGED PLAN. UNIT MAY BE MIRRORRED.
  - 005 SEE UNIT 149 ENLARGED PLAN.
  - 006 SEE UNIT 131 ENLARGED PLAN.
  - 007 SEE UNIT 122 ENLARGED PLAN.
  - 008 SEE UNIT 232 ENLARGED PLAN.
  - 009 SEE UNIT 251 ENLARGED PLAN.
  - 010 SEE UNIT 146 ENLARGED PLAN.
  - 011 SEE UNIT 124 ENLARGED PLAN.
  - 012 SEE UNIT 233 ENLARGED PLAN.
  - 013 SEE UNIT 242 ENLARGED PLAN.
  - 014 SEE UNIT 128 ENLARGED PLAN. UNIT MAY BE MIRRORRED.
  - 015 SEE UNIT 122 ENLARGED PLAN.
  - 016 SEE UNIT 232 ENLARGED PLAN.
  - 017 SEE UNIT 111 ENLARGED PLAN.
  - 018 SEE UNIT 217 ENLARGED PLAN.
  - 019 SEE UNIT 124 ENLARGED PLAN.
  - 020 SEE UNIT 234 ENLARGED PLAN.
  - 021 SEE UNIT 223 ENLARGED PLAN.
  - 022 SEE UNIT 109 ENLARGED PLAN.
  - 023 SEE UNIT 115 ENLARGED PLAN.
  - 024 SEE UNIT 132 ENLARGED PLAN. UNIT MAY BE MIRRORRED.
  - 025 SEE UNIT 232 ENLARGED PLAN.
  - 026 SEE UNIT 205 ENLARGED PLAN.
  - 027 SEE UNIT 314 ENLARGED PLAN.
  - 028 SEE UNIT 139 ENLARGED PLAN.
  - 029 SEE UNIT 140 ENLARGED PLAN.
  - 030 SEE UNIT 207 ENLARGED PLAN.
  - 031 SEE UNIT 213 ENLARGED PLAN. UNIT TO INCLUDE AUDIO AND VISUAL ALARM DEVICES FOR THE HEARING AND VISUALLY IMPAIRED. COORDINATE LOCATION WITH ELECTRICAL DRAWINGS.
  - 032 SEE UNIT 147 ENLARGED PLAN.
  - 033 SEE UNIT 122 ENLARGED PLAN.
  - 034 SEE UNIT 206 ENLARGED PLAN.
  - 035 NEW CONCRETE ON METAL DECK INFILL WITH SPRAY-APPLIED FIRE RESISTIVE MATERIAL AT NEW STEEL BEAMS AND ANGLES TO MAINTAIN FLOOR ASSEMBLY FIRE RATING. SEE OVERVIEW FLOOR PLANS FOR REQUIRED FLOOR ASSEMBLY FIRE RATINGS. SEE STRUCTURAL FOR DETAIL.
  - 036 PATCH AND REPAIR DAMAGED CONCRETE SLAB TO MATCH ADJACENT FLOOR LEVEL, FINISH AND SURFACE TEXTURE.
  - 037 PATCH AND REPAIR DAMAGED CONCRETE SLAB TO MATCH ADJACENT FLOOR LEVEL, FINISH AND SURFACE TEXTURE.
  - 038 NEW TIMBER FLOOR DECK INFILL TO MATCH EXISTING. SEE STRUCTURAL.
  - 039 NEW CONCRETE INFILL SLAB AT EXISTING SUNKEN STAIR PIT. MATCH ADJACENT FLOOR LEVEL, FINISH AND SURFACE TEXTURE.
  - 040 PATCH & REPAIR CONCRETE SLAB WHERE EMBEDDED METAL PLATES AND/OR METAL TRENCH COVERS WERE REMOVED. FILL AND LEVEL WITH NEW CONCRETE TO MATCH ADJACENT SURFACE LEVEL AND FINISH TEXTURE. FEATHER CONCRETE TO LEVEL AT EXISTING METAL FLOOR OPENING FRAMES IF PRESENT.
  - 041 NEW INFILL WALL & PRECAST SILL TO REBUILD WINDOW OPENING. SEE ELEVATIONS. TOOTH IN SALVAGED BRICK WITH NEW MORTAR TO MATCH ADJACENT HISTORIC MASONRY.
  - 042 NEW INFILL WALL TO REBUILD WINDOW & DOOR OPENING. TOOTH IN SALVAGED MASONRY WITH NEW MORTAR TO MATCH ADJACENT HISTORIC MASONRY. PARCE SURFACES TO MATCH ADJACENT HISTORIC PARCE IF PRESENT.
  - 043 NEW PARTIAL INFILL WALL ASSEMBLY TO REBUILD OPENING IN EXISTING WALL BELOW SILL AT FLOOR LEVEL. SEE ELEVATIONS. TOOTH IN SALVAGED BRICK WITH NEW MORTAR TO MATCH ADJACENT HISTORIC MASONRY. SEE DETAIL 7AS10W FOR WALL ASSEMBLY.
  - 044 PATCH & REPAIR DAMAGED WALL OPENING AT SILL. TOOTH IN SALVAGED BRICK WITH NEW MORTAR AND PROVIDE NEW SILL TO MATCH ADJACENT HISTORIC MASONRY.
  - 045 PATCH & REPAIR DAMAGED AND MISSING PLASTER RETURNS AT JAMB, HEAD AND SILL TO MATCH EXISTING RETURNS. SEE WINDOW DETAILS. AT THESE WALLS THERE WILL BE A FURRING WITH 5/8" GNB EXTENDING FROM FLOOR TO TOP OF WALL AT UNDERSIDE OF STRUCTURE.
  - 046 PATCH & REPAIR DAMAGED AND MISSING PLASTER RETURNS AT JAMB, HEAD AND SILL TO MATCH EXISTING RETURNS AT ADJACENT WINDOWS OF THE SAME TYPE.
  - 047 NEW GYPSUM BOARD INFILL WALL ASSEMBLY AT EXISTING OPENING. SEE DETAIL 1A10W.
  - 048 NEW CMU INFILL WALL ASSEMBLY AT EXISTING OPENING. SEE DETAIL 2A10W.
  - 049 NEW GYPSUM BOARD INFILL WALL ASSEMBLY AT EXISTING NON-HISTORIC WALL OPENING. MATCH EXISTING WALL ASSEMBLY WIDTH AND ADJACENT SURFACE FINISH.
  - 050 NEW METAL PANEL INFILL WALL ASSEMBLY AT EXISTING EXTERIOR MASONRY WALL OPENING. SEE DETAIL 5A10W.

NEW WORK PLAN KEY NOTES - 1/8" PLANS

- SEE PROJECT GENERAL CONDITIONS, GENERAL INFORMATION ON SHEET A010W AND SELECTIVE DEMOLITION, CUTTING AND PATCHING SPECIFICATIONS THAT ARE USED IN ASSOCIATION WITH THESE NOTES.
- NEW WORK PLAN KEY NOTES APPLY TO ALL 1/8" NEW WORK DRAWINGS AND MAY NOT BE USED ON EVERY SHEET.
- 051 NEW METAL PANEL INFILL WALL ASSEMBLY AT EXISTING WINDOW OPENING. SEE DETAIL 5A10W.
  - 052 EXISTING HISTORIC SLIDING FIRE DOOR ASSEMBLY TO REMAIN. SECURE SLIDING DOOR IN A FULLY OPEN POSITION WITH METAL Z-BRACKETS. PREPARE ENTIRE ASSEMBLY FOR PAINTED FINISH.
  - 053 EXISTING HISTORIC SLIDING FIRE DOOR ASSEMBLY TO REMAIN. SECURE SLIDING DOOR IN A CLOSED POSITION WITH METAL Z-BRACKETS. PREPARE ENTIRE ASSEMBLY FOR NEW PAINTED FINISH.
  - 054 REINSTATE SALVAGED HISTORIC SLIDING FIRE DOOR ASSEMBLY AND HARDWARE FROM THIS OPENING TO NEW ORIENTATION AS SHOWN. SECURE SLIDING DOOR IN A CLOSED POSITION WITH METAL Z-BRACKETS. PREPARE ENTIRE ASSEMBLY FOR NEW PAINTED FINISH.
  - 055 EXISTING HISTORIC COILING OVERHEAD DOOR ASSEMBLY TO REMAIN. SECURE COILING DOOR IN A FULLY OPEN POSITION. PREPARE ENTIRE ASSEMBLY FOR PAINTED FINISH.
  - 056 EXISTING HISTORIC COILING OVERHEAD DOOR ASSEMBLY TO REMAIN. SECURE COILING DOOR IN A FULLY CLOSED POSITION. PREPARE ENTIRE ASSEMBLY FOR PAINTED FINISH.
  - 057 EXISTING HISTORIC OVERHEAD DOOR ASSEMBLY TO REMAIN. REPAIR TRACK AND HARDWARE TO RETURN DOOR TO OPERATING CONDITION. PREPARE ENTIRE ASSEMBLY FOR PAINTED FINISH.
  - 058 EXISTING STEEL SASH WINDOW ASSEMBLY TO REMAIN. PREPARE ENTIRE ASSEMBLY FOR PAINTED FINISH. REPLACE BROKEN OR MISSING PANE OF GLASS WITH NEW GLASS TO MATCH EXISTING. SEE DETAIL 13AS10W.
  - 059 NEW OPENING IN EXISTING CMU WALL. TOOTH IN NEW CMU AND MORTAR TO MATCH EXISTING.
  - 060 EXISTING GLAZED WALL TILE TO REMAIN. PROTECT DURING CONSTRUCTION.
  - 061 TUCKPOINT AND REPAIR EXISTING CHIMNEY TO MATCH EXISTING MATERIALS. SEE EXTERIOR MASONRY REPORT AND DRAWINGS.
  - 062 EXISTING WOOD SINGLE HUNG WINDOW FRAME, SASH AND ALL CASING TRIM TO REMAIN. PREPARE EXISTING INTERIOR & EXTERIOR SURFACES FOR NEW PAINT. REPLACE MISSING AND/OR BROKEN GLASS TO MATCH EXISTING AND INSTALL NEW GLAZING PUTTY AT ALL PANE. INSTALL NEW INTERIOR STORM WINDOWS. SEE DETAIL 13AS10W.
  - 063 ALIGN EDGE OF DEMISING WALL WITH EDGE OF HISTORIC MASONRY OPENING.
  - 064 ALIGN CENTER OF DEMISING WALL OR PARTITION WITH CENTERLINE OF HISTORIC COLUMN OR BEAM ABOVE.
  - 065 ALIGN EDGE OF DEMISING WALL WITH EDGE OF HISTORIC CONCRETE DROP SLAB.
  - 066 ALIGN CENTER OF DEMISING WALL PARTITION WITH CENTERLINE OF WINDOW MULLION.
  - 067 ALIGN EDGE OF DEMISING WALL WITH OUTER EDGE OF LIGHT MOUNTING COLLAR.
  - 068 ALIGN CENTER OF DEMISING WALL OR PARTITION WITH CENTER OF HISTORIC SKYLIGHT MULLION ABOVE.
  - 069 NEW 3'X3 ACCESS DOOR W/ 3-HR RATING @ WALL TO ABANDONED MECHANICAL TUNNEL.
  - 070 NEW CONCRETE SLAB AT EXISTING STOOP TO MATCH FLOOR HEIGHT AT BUILDING 7. SEE STRUCTURAL.
  - 071 EXISTING WOOD STAIR GUARD AND HANDRAIL TO REMAIN. PREP ALL SURFACES FOR NEW PAINT.
  - 072 EXISTING WOOD STAIR GUARD AND HANDRAIL TO REMAIN. REPAIR/REPLACE MISSING BEAD BOARD HANDRAIL SUPPORT AND STAIR RUN FROM LEVEL 01 TO 1ST LANDING TO MATCH EXISTING HISTORIC CONDITION PERCENT. PROVIDE NEW STEEL HANDRAIL AT EXISTING CMU WALLS. PREP ALL SURFACES FOR NEW PAINT.
  - 073 EXISTING CONCRETE STAIR, CMU GUARD WALL AND HANDRAIL TO REMAIN. PREP ALL SURFACES FOR NEW FINISHES.
  - 074 PROVIDE NEW EGRESS BARRIER GATE AT EXISTING STEEL GUARDRAIL. EXISTING CONCRETE STAIR, STEEL GUARDRAIL AND HANDRAIL TO REMAIN. PREP ALL SURFACES FOR NEW FINISHES.
  - 075 NEW CHAIRING IN FLOOR TO MATCH EXISTING FINISH AND SURFACE TEXTURE.
  - 076 BUILD TYPE PB UNIT DEMISING WALL WITH RESILIENT CHANNEL ON THIS SIDE.
  - 077 TAPER GYPCRETE TOPPING 120 SLOPE MAX TO MEET EXISTING FINISH LEVEL AT TRANSITION AREA TO STAIRS OR BETWEEN BUILDINGS.
  - 078 NEW TAPERED POLISHED EPOXY FLOOR TOPPING TO TRANSITION FLOOR FINISH LEVEL CHANGE BETWEEN BUILDINGS 6 & 7. TAPER 1:20 SLOPE MAX.
  - 079 PATCH AND REPAIR DAMAGED AND MISSING EXTERIOR STUCCO TO MATCH ADJACENT SURFACE.

- GENERAL FLOOR PLAN NOTES TO CONTRACTOR
1. THIS DRAWING IS FURTHER SUPPORTED BY INFORMATION CONTAINED IN THE SPECIFICATION MANUAL.
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  3. DO NOT SCALE DRAWINGS. CONTRACTOR TO VERIFY ALL CONDITIONS AND DIMENSIONS AT THE JOB SITE PRIOR TO COMMENCING CONSTRUCTION.
  4. FLOOR ELEVATIONS ARE TO THE TOP OF THE SUB-FLOOR MATERIAL UNLESS OTHERWISE NOTED.
  5. CONTRACTORS SHALL JOINTLY PROVIDE AND INSTALL ALL STIFFENERS, BRACING, BACKING PLATES, WALL BLOCKING AND SUPPORTING BRACKETS REQUIRED FOR THE INSTALLATION OF CASEWORK, TOILET ACCESSORIES, PARTITIONS, MILLWORK, AND ALL WORK MOUNTED OR SUSPENDED BY ALL TRADES.

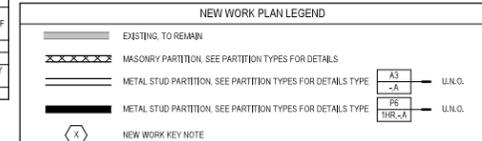

FLOOR ASSEMBLY SUMMARY			
	LEVEL 01	LEVEL 02	LEVEL 03
BLDG. 4 MAIN AREA	EXISTING CONCRETE SLAB-ON-GRADE		
BLDG. 4 AT PARTIAL BASEMENT	-EXISTING 6" CONCRETE SLAB -ASSEMBLY FIRE RATING: 1 HOUR		
BLDG. 5	EXISTING CONCRETE SLAB-ON-GRADE		
BLDG. 6	-EXISTING 10 1/2" CONCRETE SLAB -ASSEMBLY FIRE RATING: 1 HOUR	-EXISTING 10 1/2" CONCRETE SLAB -ASSEMBLY FIRE RATING: 1 HOUR -STC-0 RATING	
BLDG. 7	EXISTING CONCRETE SLAB-ON-GRADE	- FINISH FLOORING (SEE FINISH PLANS FOR MATERIALS AND LOCATIONS OF FINISH MATERIALS) - NEW 1-1/2" GYPSUM CEMENT UNDERLAYMENT - NEW ACOUSTIC SOUND MAT (AT NON-CARPETED AREAS ONLY) - EXISTING 2" TIMBER SUBFLOORING - EXISTING 7X13 TIMBER FLOOR JOISTS (NDS CH. 16 CALCULATED CHAR RATE MEETS 12-HOUR RATING) - INDERSIDE OF EXISTING WOOD SUBFLOORING TO RECEIVE NEW INTUMESCENT COATINGS. - ASSEMBLY FIRE RATING: 1 1/2 HOUR - FSTC: 45-49 FIC: 45-47	
BLDG. 8A	- FINISH FLOORING (SEE FINISH PLANS FOR MATERIALS AND LOCATIONS OF FINISH MATERIALS) - EXISTING CONCRETE SLAB ON GRADE	- FINISH FLOORING (SEE FINISH PLANS FOR MATERIALS AND LOCATIONS OF FINISH MATERIALS) - NEW 1-1/2" GYPSUM CEMENT UNDERLAYMENT - NEW ACOUSTIC SOUND MAT (AT NON-CARPETED AREAS ONLY) - EXISTING 2" TIMBER SUBFLOORING (NDS CH. 16 CALCULATED CHAR RATE MEETS 12-HOUR RATING) - EXISTING 6X14 TIMBER FLOOR JOIST (NDS CH. 16 CALCULATED CHAR RATE MEETS 12-HOUR RATING) - ASSEMBLY FIRE RATING: 1 1/2 HOUR - FSTC: 45-49 FIC: 45-47	- FINISH FLOORING (SEE FINISH PLANS FOR MATERIALS AND LOCATIONS OF FINISH MATERIALS) - NEW 1-1/2" GYPSUM CEMENT UNDERLAYMENT - NEW ACOUSTIC SOUND MAT (AT NON-CARPETED AREAS ONLY) - EXISTING 2" TIMBER SUBFLOORING (NDS CH. 16 CALCULATED CHAR RATE MEETS 12-HOUR RATING) - EXISTING 6X14 TIMBER FLOOR JOIST (NDS CH. 16 CALCULATED CHAR RATE MEETS 12-HOUR RATING) - ASSEMBLY FIRE RATING: 1 1/2 HOUR - FSTC: 45-49 FIC: 45-47
BLDG. 8A @ ELEVATOR CORE	EXISTING CONCRETE SLAB-ON-GRADE	- EXISTING 3" CONCRETE SLAB - EXISTING 10" CLAY TILE INFILL - ASSEMBLY FIRE RATING: 1 HOUR	- EXISTING 3" CONCRETE SLAB - EXISTING 10" CLAY TILE INFILL - ASSEMBLY FIRE RATING: 1 HOUR
BLDG. 8B	EXISTING CONCRETE SLAB-ON-GRADE	- FINISH FLOORING (SEE FINISH PLANS FOR MATERIALS AND LOCATIONS OF FINISH MATERIALS) - NEW 1-1/2" GYPSUM CEMENT UNDERLAYMENT - NEW ACOUSTIC SOUND MAT (AT NON-CARPETED AREAS ONLY) - EXISTING 2" TIMBER SUBFLOORING (NDS CH. 16 CALCULATED CHAR RATE MEETS 12-HOUR RATING) - EXISTING 6X14 TIMBER FLOOR JOIST (NDS CH. 16 CALCULATED CHAR RATE MEETS 12-HOUR RATING) - ASSEMBLY FIRE RATING: 1 1/2 HOUR - FSTC: 45-49 FIC: 45-47	


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CONSULTANTS


COMMUNITY WITHIN THE CORRIDOR - WEST BLOCK  
2758 N. 38RD STREET  
MILWAUKEE, WI 53210

REVISIONS  
1 10/09/20 ADDENDUM #1

SCALE	VARES
PROJECT NUMBER	200102
SET TYPE	CONSTRUCTION DOCUMENTS
DATE ISSUED	9/25/20
SHEET NUMBER	A220W

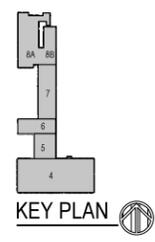

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**2 NEW WORK PLAN - LEVEL 02 - BUILDING 7**  
Scale: 1/8" = 1'-0"


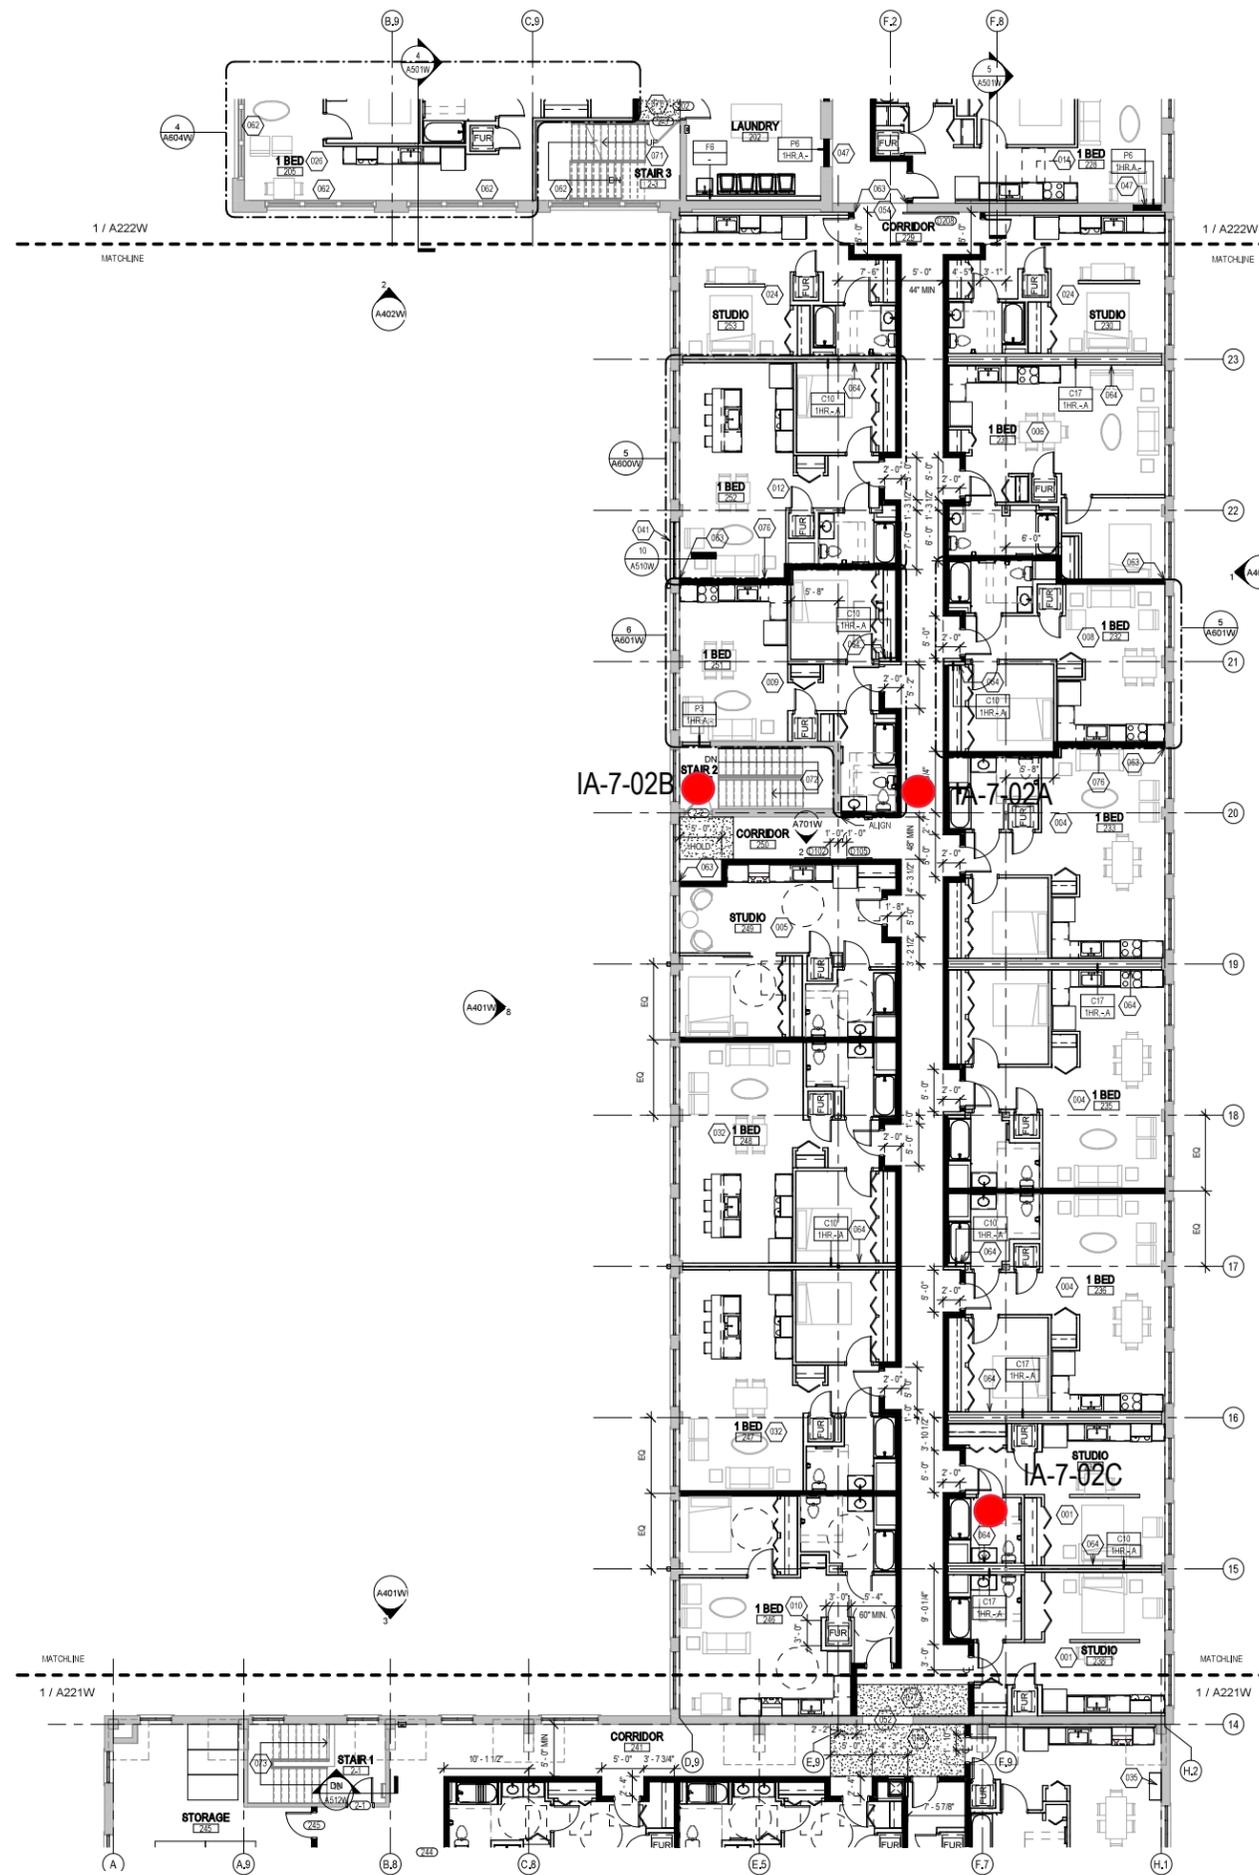
**NEW WORK PLAN KEY NOTES - 1/8" PLANS**

- SEE PROJECT GENERAL CONDITIONS, GENERAL INFORMATION ON SHEET A001W AND SELECTIVE DEMOLITION, CUTTING AND PATCHING SPECIFICATIONS THAT ARE USED IN ASSOCIATION WITH THESE NOTES.
- NEW WORK PLAN KEY NOTES APPLY TO ALL 1/8" NEW WORK DRAWINGS AND MAY NOT BE USED ON EVERY SHEET.
- 001 SEE UNIT 137 ENLARGED PLAN.
  - 002 SEE UNIT 105 ENLARGED PLAN.
  - 003 SEE UNIT 113 ENLARGED PLAN.
  - 004 SEE UNIT 118 ENLARGED PLAN. UNIT MAY BE MIRRORRED.
  - 005 SEE UNIT 149 ENLARGED PLAN.
  - 006 SEE UNIT 131 ENLARGED PLAN.
  - 007 SEE UNIT 132 ENLARGED PLAN.
  - 008 SEE UNIT 233 ENLARGED PLAN.
  - 009 SEE UNIT 251 ENLARGED PLAN.
  - 010 SEE UNIT 148 ENLARGED PLAN.
  - 011 SEE UNIT 151 ENLARGED PLAN.
  - 012 SEE UNIT 225 ENLARGED PLAN.
  - 013 SEE UNIT 242 ENLARGED PLAN.
  - 014 SEE UNIT 128 ENLARGED PLAN. UNIT MAY BE MIRRORRED.
  - 015 SEE UNIT 122 ENLARGED PLAN.
  - 016 SEE UNIT 221 ENLARGED PLAN.
  - 017 SEE UNIT 111 ENLARGED PLAN.
  - 018 SEE UNIT 217 ENLARGED PLAN.
  - 019 SEE UNIT 124 ENLARGED PLAN.
  - 020 SEE UNIT 224 ENLARGED PLAN.
  - 021 SEE UNIT 223 ENLARGED PLAN.
  - 022 SEE UNIT 109 ENLARGED PLAN.
  - 023 SEE UNIT 115 ENLARGED PLAN.
  - 024 SEE UNIT 130 ENLARGED PLAN. UNIT MAY BE MIRRORRED.
  - 025 SEE UNIT 215 ENLARGED PLAN.
  - 026 SEE UNIT 205 ENLARGED PLAN.
  - 027 SEE UNIT 314 ENLARGED PLAN.
  - 028 SEE UNIT 139 ENLARGED PLAN.
  - 029 SEE UNIT 140 ENLARGED PLAN.
  - 030 SEE UNIT 207 ENLARGED PLAN.
  - 031 SEE UNIT 213 ENLARGED PLAN. UNIT TO INCLUDE AUDIO AND VISUAL ALARM DEVICES FOR THE HEARING AND VISUALLY IMPAIRED. COORDINATE LOCATION WITH ELECTRICAL DRAWINGS.
  - 032 SEE UNIT 140 ENLARGED PLAN.
  - 033 SEE UNIT 127 ENLARGED PLAN.
  - 034 SEE UNIT 206 ENLARGED PLAN.
  - 035 NEW CONCRETE ON METAL DECK INFILL WITH SPRAY-APPLIED FIRE RESISTIVE MATERIAL AT NEW STEEL BEAMS AND ANGLES TO MAINTAIN FLOOR ASSEMBLY FIRE RATING. SEE OVERVIEW FLOOR PLANS FOR REQUIRED FLOOR ASSEMBLY FIRE RATINGS. SEE STRUCTURAL FOR DETAIL.
  - 036 NEW CONCRETE INFILL AT EXISTING PIT MATCH ADJACENT FLOOR LEVEL, FINISH AND SURFACE TEXTURE.
  - 037 PATCH AND REPAIR DAMAGED CONCRETE SLAB MATCH ADJACENT FLOOR LEVEL, FINISH AND SURFACE TEXTURE.
  - 038 NEW TIMBER FLOOR DECK INFILL TO MATCH EXISTING. SEE STRUCTURAL.
  - 039 NEW CONCRETE INFILL SLAB AT EXISTING SUNKEN STAIR PIT MATCH ADJACENT FLOOR LEVEL, FINISH AND SURFACE TEXTURE.
  - 040 PATCH & REPAIR CONCRETE SLAB WHERE EMBEDDED METAL PLATES AND/OR METAL TRENCH COVERS WERE REMOVED. FILL AND LEVEL WITH NEW CONCRETE TO MATCH ADJACENT SURFACE LEVEL AND FINISH TEXTURE. FEATHER CONCRETE TO LEVEL AT EXISTING METAL FLOOR OPENING FRAMES IF PRESENT.
  - 041 NEW INFILL WALL & PRECAST SILL TO REBUILD WINDOW OPENING. SEE ELEVATIONS. TOOTH IN SALVAGED BRICK WITH NEW MORTAR TO MATCH ADJACENT HISTORIC MASONRY.
  - 042 NEW INFILL WALL TO REBUILD WINDOW & DOOR OPENING. TOOTH IN SALVAGED MASONRY WITH NEW MORTAR TO MATCH ADJACENT HISTORIC MASONRY PARALLEL SURFACES TO MATCH ADJACENT HISTORIC PARSE IF PRESENT.
  - 043 NEW PARTIAL INFILL WALL ASSEMBLY TO REBUILD OPENING IN EXISTING WALL BELOW SILL AT FLOOR LEVEL. SEE ELEVATIONS. TOOTH IN SALVAGED BRICK WITH NEW MORTAR TO MATCH ADJACENT HISTORIC MASONRY. SEE DETAIL 7A1510W FOR WALL ASSEMBLY.
  - 044 PATCH & REPAIR DAMAGED WALL OPENING AT SILL. TOOTH IN SALVAGED BRICK WITH NEW MORTAR AND PROVIDE NEW SILL TO MATCH ADJACENT HISTORIC MASONRY.
  - 045 PATCH & REPAIR DAMAGED AND MISSING PLASTER RETURNS AT JAMB, HEAD AND SILL TO MATCH EXISTING RETURNS. SEE WINDOW DETAILS. AT THESE WALLS THERE WILL BE A FURRING WITH 3/8" GWS EXTENDING FROM FLOOR TO TOP OF WALL AT UNDERSIDE OF STRUCTURE.
  - 046 PATCH & REPAIR DAMAGED AND MISSING PLASTER LATH FURRING WALL. PATCH AND REPAIR EXISTING RADICISED PLASTER RETURN PROFILES IF DAMAGED AT JAMB, HEAD AND SILL TO MATCH EXISTING RETURNS AT ADJACENT WINDOWS OF THE SAME TYPE.
  - 047 NEW GYPSUM BOARD INFILL WALL ASSEMBLY AT EXISTING OPENING. SEE DETAIL 1A107W.
  - 048 NEW CMU INFILL WALL ASSEMBLY AT EXISTING OPENING. SEE DETAIL 2A107W.
  - 049 NEW GYPSUM BOARD INFILL WALL ASSEMBLY AT EXISTING NON-HISTORIC WALL OPENING. MATCH EXISTING WALL ASSEMBLY WIDTH AND ADJACENT SURFACE FINISH.
  - 050 NEW METAL PANEL INFILL WALL ASSEMBLY AT EXISTING EXTERIOR MASONRY WALL OPENING. SEE DETAIL S410W.

**NEW WORK PLAN KEY NOTES - 1/8" PLANS**

- SEE PROJECT GENERAL CONDITIONS, GENERAL INFORMATION ON SHEET A001W AND SELECTIVE DEMOLITION, CUTTING AND PATCHING SPECIFICATIONS THAT ARE USED IN ASSOCIATION WITH THESE NOTES.
- NEW WORK PLAN KEY NOTES APPLY TO ALL 1/8" NEW WORK DRAWINGS AND MAY NOT BE USED ON EVERY SHEET.
- 051 NEW METAL PANEL INFILL WALL ASSEMBLY AT EXISTING WINDOW OPENING. SEE DETAIL S410W.
  - 052 EXISTING HISTORIC SLIDING FIRE DOOR ASSEMBLY TO REMAIN. SECURE SLIDING DOOR IN A FULLY OPEN POSITION WITH METAL Z-BRACKETS. PREPARE ENTIRE ASSEMBLY FOR PAINTED FINISH.
  - 053 EXISTING HISTORIC SLIDING FIRE DOOR ASSEMBLY TO REMAIN. SECURE SLIDING DOOR IN A CLOSED POSITION WITH METAL Z-BRACKETS. PREPARE ENTIRE ASSEMBLY FOR NEW PAINTED FINISH.
  - 054 REINFORCING SALVAGED HISTORIC SLIDING FIRE DOOR ASSEMBLY AND HARDWARE FROM THIS OPENING TO NEW ORIENTATION AS SHOWN. SECURE SLIDING DOOR IN A CLOSED POSITION WITH METAL Z-BRACKETS. PREPARE ENTIRE ASSEMBLY FOR NEW PAINTED FINISH.
  - 055 EXISTING HISTORIC OVERHEAD DOOR ASSEMBLY TO REMAIN. SECURE COILING DOOR IN A FULLY OPEN POSITION. PREPARE ENTIRE ASSEMBLY FOR PAINTED FINISH.
  - 056 EXISTING HISTORIC COILING OVERHEAD DOOR ASSEMBLY TO REMAIN. SECURE COILING DOOR IN A FULLY CLOSED POSITION. PREPARE ENTIRE ASSEMBLY FOR PAINTED FINISH.
  - 057 EXISTING HISTORIC OVERHEAD DOOR ASSEMBLY TO REMAIN. REPAIR TRACK AND HARDWARE TO RETURN DOOR TO OPERATING CONDITION. PREPARE ENTIRE ASSEMBLY FOR PAINTED FINISH.
  - 058 EXISTING STEEL SASH WINDOW ASSEMBLY TO REMAIN. PREPARE ENTIRE ASSEMBLY FOR PAINTED FINISH. REPLACE BROKEN OR MISSING PANE OF GLASS WITH NEW GLASS TO MATCH EXISTING.
  - 059 NEW OPENING IN EXISTING CMU WALL. TOOTH IN NEW CMU AND MORTAR TO MATCH EXISTING.
  - 060 EXISTING GLAZED WALL TILE TO REMAIN. PROTECT DURING CONSTRUCTION.
  - 061 TUCKPOINT AND REPAIR EXISTING CHIMNEY TO MATCH EXISTING MATERIALS. SEE EXTERIOR MASONRY REPORT AND DRAWINGS.
  - 062 EXISTING WOOD SINGLE HUNG WINDOW FRAME, SASH AND ALL CASING/TRIM TO REMAIN. PREPARE EXISTING INTERIOR & EXTERIOR SURFACES FOR NEW PAINT. REPLACE MISSING AND/OR BROKEN GLASS TO MATCH EXISTING AND INSTALL NEW ALIGN EDGE OF DEMISING WALL WITH EDGE OF HISTORIC MASONRY OPENING. SEE DETAIL 13A1510W.
  - 063 ALIGN CENTER OF DEMISING WALL WITH EDGE OF HISTORIC MASONRY OPENING.
  - 064 ALIGN CENTER OF DEMISING WALL OR PARTITION WITH CENTERLINE OF HISTORIC COLUMN, OR BEAM ABOVE.
  - 065 ALIGN EDGE OF DEMISING WALL WITH EDGE OF HISTORIC CONCRETE DROP SLAB.
  - 066 ALIGN CENTER OF DEMISING WALL PARTITION WITH CENTERLINE OF WINDOW MULLION.
  - 067 ALIGN EDGE OF DEMISING WALL WITH OUTER EDGE OF LIGHT MOUNT OR W/LINE.
  - 068 ALIGN CENTER OF DEMISING WALL OR PARTITION WITH CENTER OF HISTORIC SKYLIGHT MULLION ABOVE.
  - 069 NEW 3X3 ACCESS DOOR W/ 3-HR RATING @ WALL TO ABANDONED MECHANICAL TUNNEL.
  - 070 NEW CONCRETE SLAB AT EXISTING STOOP TO MATCH FLOOR HEIGHT AT BUILDING 7. SEE STRUCTURAL.
  - 071 EXISTING WOOD STAIR, GUARD AND HANDRAILS TO REMAIN. PREP ALL SURFACES FOR NEW PAINT.
  - 072 EXISTING WOOD STAIR, GUARD AND HANDRAIL TO REMAIN. REPAIR/REPLACE MISSING BEAD BOARD HANDRAIL SUPPORT AND STAIR RUN FROM LEVEL 01 TO 1ST LANDING TO MATCH EXISTING HISTORIC CONDITION PERCENT. PROVIDE NEW STEEL HANDRAILS AT EXISTING CMU WALLS. PREP ALL SURFACES FOR NEW PAINT.
  - 073 EXISTING CONCRETE STAIR, CMU GUARD WALL AND HANDRAIL TO REMAIN. PREP ALL SURFACES FOR NEW FINISHES.
  - 074 PROVIDE NEW EGRESS BARRIER GATE AT EXISTING STEEL GUARDRAIL. EXISTING CONCRETE STAIR, STEEL GUARDRAIL AND HANDRAIL TO REMAIN. PREP ALL SURFACES FOR NEW FINISHES.
  - 075 NEW CONCRETE STAIR, GUARD AND HANDRAILS TO REMAIN. PREP ALL SURFACES FOR NEW PAINT.
  - 076 BUILD TYPE P6 UNIT DEMISING WALL WITH RESILIENT CHANNEL ON THIS SIDE.
  - 077 TAPERED CONCRETE TAPPING TO SLOPE MAX TO MEET EXISTING FINISH LEVEL OF TRANSITION AREA TO STAIRS OR ELEVATOR BUILDINGS.
  - 078 NEW TAPERED POLISHED EPOXY FLOOR TOPPING TO TRANSITION FLOOR FINISH LEVEL CHANGE BETWEEN BUILDINGS 6 & 7. TAPER 1:20 SLOPE MAX.
  - 079 PATCH AND REPAIR DAMAGED AND MISSING EXTERIOR STUCCO TO MATCH ADJACENT SURFACE.

- GENERAL FLOOR PLAN NOTES TO CONTRACTOR**
- THIS DRAWING IS FURTHER SUPPORTED BY INFORMATION CONTAINED IN THE SPECIFICATION MANUAL.
  - THE CIVIL, STRUCTURAL, MECHANICAL, ELECTRICAL, PLUMBING, FIRE PROTECTION, AUDIO-VISUAL, AND SECURITY DRAWINGS ARE SUPPLEMENTARY TO THE ARCHITECTURAL DRAWINGS. IT SHALL BE THE RESPONSIBILITY OF THE CONTRACTOR TO COORDINATE THE INFORMATION CONTAINED IN ALL THE DRAWINGS BEFORE THE INSTALLATION OF ALL WORK.
  - DO NOT SCALE DRAWINGS. CONTRACTOR TO VERIFY ALL CONDITIONS AND DIMENSIONS AT THE JOB SITE PRIOR TO COMMENCING CONSTRUCTION.
  - FLOOR ELEVATIONS ARE TO THE TOP OF THE SUB-FLOOR MATERIAL UNLESS OTHERWISE NOTED.
  - CONTRACTORS SHALL JOINTLY PROVIDE AND INSTALL ALL STIFFENERS, BRACING, BACKING PLATES, WALL BLOCKING AND SUPPORTING BRACKETS REQUIRED FOR THE INSTALLATION OF CASEWORK, TOILET ACCESSORIES, PARTITIONS, MILLWORK, AND ALL WORK MOUNTED OR SUSPENDED BY WALL TRADES.

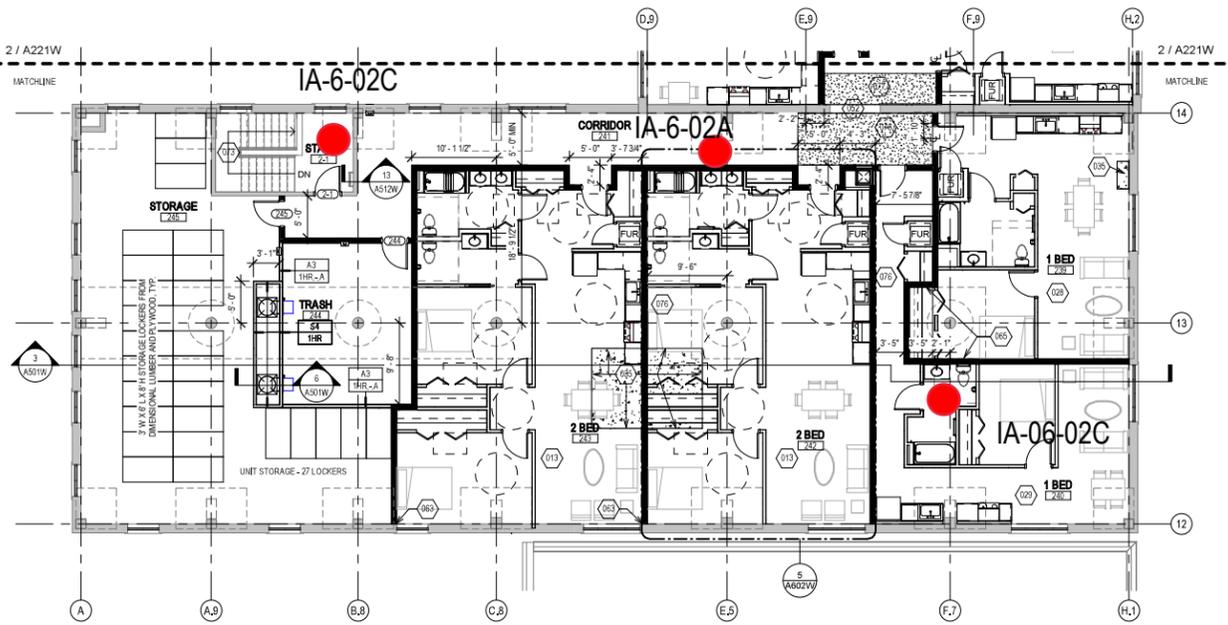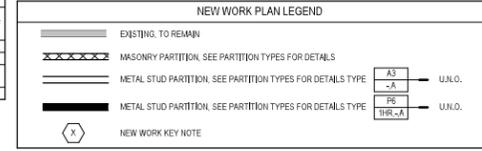

**1 NEW WORK PLAN - LEVEL 02 - BUILDING 6**  
Scale: 1/8" = 1'-0"

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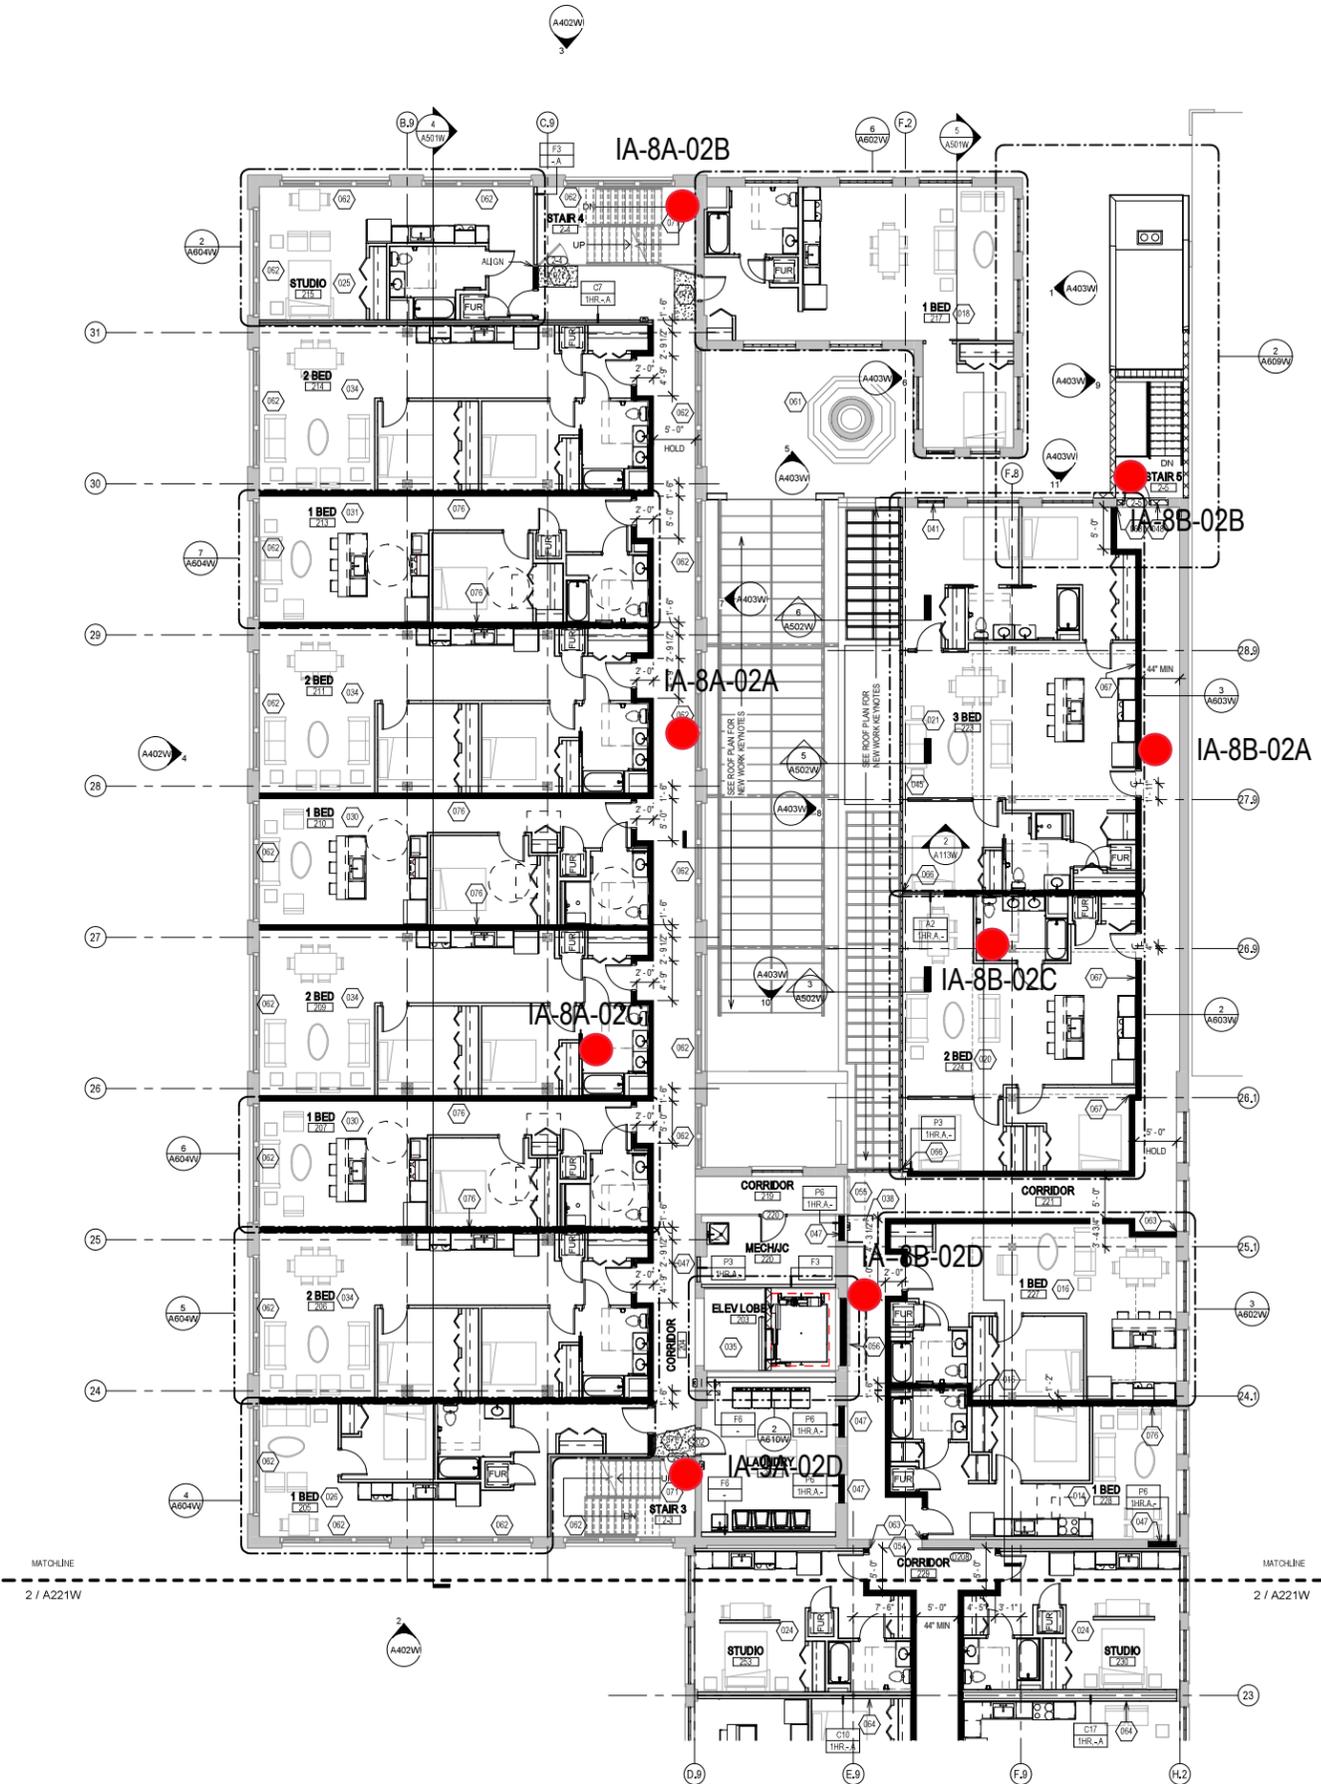
2758 N. 38RD STREET  
MILWAUKEE, WI 53210

SHEET TITLE  
**NEW WORK PLAN - LEVEL 02 - BUILDINGS 6 & 7**

REVISIONS  
1 10/09/20 ADDENDUM #1

SCALE	VARES
PROJECT NUMBER	200102
SET TYPE	<b>CONSTRUCTION DOCUMENTS</b>
DATE ISSUED	9/25/20
SHEET NUMBER	<b>A221W</b>

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**NEW WORK PLAN KEY NOTES - 1/8" PLANS**

SEE PROJECT GENERAL CONDITIONS, GENERAL INFORMATION ON SHEET A001W AND SELECTIVE DEMOLITION, CUTTING AND PATCHING SPECIFICATIONS THAT ARE USED IN ASSOCIATION WITH THESE NOTES.

NEW WORK PLAN KEY NOTES APPLY TO ALL 1/8" NEW WORK DRAWINGS AND MAY NOT BE USED ON EVERY SHEET.

- SEE UNIT 137 ENLARGED PLAN.
- SEE UNIT 105 ENLARGED PLAN.
- SEE UNIT 113 ENLARGED PLAN.
- SEE UNIT 118 ENLARGED PLAN. UNIT MAY BE MIRRORED.
- SEE UNIT 149 ENLARGED PLAN.
- SEE UNIT 131 ENLARGED PLAN.
- SEE UNIT 132 ENLARGED PLAN.
- SEE UNIT 232 ENLARGED PLAN.
- SEE UNIT 251 ENLARGED PLAN.
- SEE UNIT 148 ENLARGED PLAN.
- SEE UNIT 151 ENLARGED PLAN.
- SEE UNIT 224 ENLARGED PLAN.
- SEE UNIT 242 ENLARGED PLAN.
- SEE UNIT 128 ENLARGED PLAN. UNIT MAY BE MIRRORED.
- SEE UNIT 122 ENLARGED PLAN.
- SEE UNIT 221 ENLARGED PLAN.
- SEE UNIT 242 ENLARGED PLAN.
- SEE UNIT 111 ENLARGED PLAN.
- SEE UNIT 217 ENLARGED PLAN.
- SEE UNIT 124 ENLARGED PLAN.
- SEE UNIT 224 ENLARGED PLAN.
- SEE UNIT 223 ENLARGED PLAN.
- SEE UNIT 109 ENLARGED PLAN.
- SEE UNIT 115 ENLARGED PLAN.
- SEE UNIT 133 ENLARGED PLAN. UNIT MAY BE MIRRORED.
- SEE UNIT 215 ENLARGED PLAN.
- SEE UNIT 205 ENLARGED PLAN.
- SEE UNIT 314 ENLARGED PLAN.
- SEE UNIT 139 ENLARGED PLAN.
- SEE UNIT 140 ENLARGED PLAN.
- SEE UNIT 207 ENLARGED PLAN.
- SEE UNIT 213 ENLARGED PLAN. UNIT TO INCLUDE AUDIO AND VISUAL ALARM DEVICES FOR THE HEARING AND VISUALLY IMPAIRED. COORDINATE LOCATION WITH ELECTRICAL DRAWINGS.
- SEE UNIT 140 ENLARGED PLAN.
- SEE UNIT 122 ENLARGED PLAN.
- SEE UNIT 206 ENLARGED PLAN.
- NEW CONCRETE ON METAL DECK INFILL WITH SPRAY-APPLIED FIRE RESISTIVE MATERIAL AT NEW STEEL BEAMS AND ANGLES TO MAINTAIN FLOOR ASSEMBLY FIRE RATING. SEE OVERVIEW FLOOR PLANS FOR REQUIRED FLOOR ASSEMBLY FIRE RATINGS. SEE STRUCTURAL FOR DETAIL.
- NEW CONCRETE INFILL AT EXISTING PIT. MATCH ADJACENT FLOOR LEVEL, FINISH AND SURFACE TEXTURE.
- PATCH AND REPAIR DAMAGED CONCRETE SLAB TO MATCH ADJACENT FLOOR LEVEL, FINISH AND SURFACE TEXTURE.
- NEW TAPERED POLISHED EPOXY FLOOR TOPPING TO TRANSITION FLOOR FINISH LEVEL CHANGE BETWEEN BUILDINGS 6 & 7. TAPER 1:20 SLOPE MAX.
- NEW CONCRETE INFILL SLAB AT EXISTING SUNKEN STAIR PIT. MATCH ADJACENT FLOOR LEVEL, FINISH AND SURFACE TEXTURE.
- PATCH & REPAIR CONCRETE SLAB WHERE EMBEDDED METAL PLATES AND/OR METAL TRENCH COVERS WERE REMOVED. FILL AND LEVEL WITH NEW CONCRETE TO MATCH ADJACENT SURFACE LEVEL AND FINISH TEXTURE. FEATHER CONCRETE TO LEVEL AT EXISTING METAL FLOOR OPENING FRAMES IF PRESENT.
- NEW INFILL WALL & PRECAST SILL TO REBUILD WINDOW OPENING. SEE ELEVATIONS. TOOTH IN SALVAGED BRICK WITH NEW MORTAR TO MATCH ADJACENT HISTORIC MASONRY.
- NEW INFILL WALL TO REBUILD WINDOW & DOOR OPENING. TOOTH IN SALVAGED MASONRY WITH NEW MORTAR TO MATCH ADJACENT HISTORIC MASONRY. PARGE SURFACES TO MATCH ADJACENT HISTORIC PARGE IF PRESENT.
- NEW PARTIAL INFILL WALL ASSEMBLY TO REBUILD OPENING IN EXISTING WALL BELOW SILL AT FLOOR LEVEL. SEE ELEVATIONS. TOOTH IN SALVAGED BRICK WITH NEW MORTAR TO MATCH ADJACENT HISTORIC MASONRY. SEE DETAIL 71A510W FOR WALL ASSEMBLY.
- PATCH & REPAIR DAMAGED WALL OPENING AT SILL. TOOTH IN SALVAGED BRICK WITH NEW MORTAR AND PROVIDE NEW SILL TO MATCH ADJACENT HISTORIC MASONRY.
- PATCH & REPAIR DAMAGED AND MISSING PLASTER RETURNS AT JAMB, HEAD AND SILL TO MATCH EXISTING RETURNS. SEE WINDOW DETAILS. AT THESE WALLS THERE WILL BE A FURRING WITH 3/8" GWB EXTENDING FROM FLOOR TO TOP OF WALL AT UNDERSIDE OF STRUCTURE.
- PATCH & REPAIR DAMAGED AND MISSING PLASTER WOOD LATH FURRING WALL. PATCH AND REPAIR EXISTING RADICUSED PLASTER RETURN PROFILES IF DAMAGED AT JAMB, HEAD AND SILL TO MATCH EXISTING RETURNS AT ADJACENT WINDOWS OF THE SAME TYPE.
- NEW GYPSUM BOARD INFILL WALL ASSEMBLY AT EXISTING OPENING. SEE DETAIL 11A110W.
- NEW CMU INFILL WALL ASSEMBLY AT EXISTING OPENING. SEE DETAIL 21A110W.
- NEW GYPSUM BOARD INFILL WALL ASSEMBLY AT EXISTING NON-HISTORIC WALL OPENING. MATCH EXISTING WALL ASSEMBLY WIDTH AND ADJACENT SURFACE FINISH.
- NEW METAL PANEL INFILL WALL ASSEMBLY AT EXISTING EXTERIOR MASONRY WALL OPENING. SEE DETAIL 5A510W.

**NEW WORK PLAN KEY NOTES - 1/8" PLANS**

SEE PROJECT GENERAL CONDITIONS, GENERAL INFORMATION ON SHEET A001W AND SELECTIVE DEMOLITION, CUTTING AND PATCHING SPECIFICATIONS THAT ARE USED IN ASSOCIATION WITH THESE NOTES.

NEW WORK PLAN KEY NOTES APPLY TO ALL 1/8" NEW WORK DRAWINGS AND MAY NOT BE USED ON EVERY SHEET.

- NEW METAL PANEL INFILL WALL ASSEMBLY AT EXISTING WINDOW OPENING. SEE DETAIL 5A510W.
- EXISTING HISTORIC SLIDING FIRE DOOR ASSEMBLY TO REMAIN. SECURE SLIDING DOOR IN A FULLY OPEN POSITION WITH METAL Z-BRACKETS. PREPARE ENTIRE ASSEMBLY FOR PAINTED FINISH.
- EXISTING HISTORIC SLIDING FIRE DOOR ASSEMBLY TO REMAIN. SECURE SLIDING DOOR IN A CLOSED POSITION WITH METAL Z-BRACKETS. PREPARE ENTIRE ASSEMBLY FOR NEW PAINTED FINISH.
- REINFORCE SALVAGED HISTORIC SLIDING FIRE DOOR ASSEMBLY AND HARDWARE FROM THIS OPENING TO NEW ORIENTATION AS SHOWN. SECURE SLIDING DOOR IN A CLOSED POSITION WITH METAL Z-BRACKETS. PREPARE ENTIRE ASSEMBLY FOR NEW PAINTED FINISH.
- EXISTING HISTORIC COILING OVERHEAD DOOR ASSEMBLY TO REMAIN. SECURE COILING DOOR IN A FULLY OPEN POSITION. PREPARE ENTIRE ASSEMBLY FOR PAINTED FINISH.
- EXISTING HISTORIC COILING OVERHEAD DOOR ASSEMBLY TO REMAIN. SECURE COILING DOOR IN A FULLY CLOSED POSITION. PREPARE ENTIRE ASSEMBLY FOR PAINTED FINISH.
- EXISTING HISTORIC OVERHEAD DOOR ASSEMBLY TO REMAIN. REPAIR TRACK AND HARDWARE TO RETURN DOOR TO OPERATING CONDITION. PREPARE ENTIRE ASSEMBLY FOR PAINTED FINISH.
- EXISTING STEEL SASH WINDOW ASSEMBLY TO REMAIN. PREPARE ENTIRE ASSEMBLY FOR PAINTED FINISH. REPLACE BROKEN OR MISSING PANE OF GLASS WITH NEW GLASS TO MATCH EXISTING.
- NEW OPENING IN EXISTING CMU WALL. TOOTH IN NEW CMU AND MORTAR TO MATCH EXISTING.
- SEE UNIT 111 ENLARGED PLAN.
- EXISTING GLAZED WALL TILE TO REMAIN. PROTECT DURING CONSTRUCTION.
- TUCKPOINT AND REPAIR EXISTING CHIMNEY TO MATCH EXISTING MATERIALS. SEE EXTERIOR MASONRY REPORT AND DRAWINGS.
- EXISTING WOOD SINGLE HUNG WINDOW FRAME, SASH AND ALL CASING/TRIM TO REMAIN. PREPARE EXISTING INTERIOR & EXTERIOR SURFACES FOR NEW PAINT. REPLACE MISSING AND/OR BROKEN GLASS TO MATCH EXISTING AND INSTALL NEW GLAZING PUTTY AT ALL PANELS. INSTALL NEW INTERIOR STORM WINDOWS. SEE DETAIL 13A510W.
- ALIGN EDGE OF DEMISING WALL WITH EDGE OF HISTORIC MASONRY OPENING.
- ALIGN CENTER OF DEMISING WALL OR PARTITION WITH CENTERLINE OF HISTORIC COLUMN, OR BEAM ABOVE.
- ALIGN EDGE OF DEMISING WALL WITH EDGE OF HISTORIC CONCRETE DROP SLAB.
- ALIGN CENTER OF DEMISING WALL PARTITION WITH CENTERLINE OF WINDOW MULLION.
- ALIGN EDGE OF DEMISING WALL WITH OUTER EDGE OF LIGHT MOUNT OR VOLUME.
- ALIGN CENTER OF DEMISING WALL OR PARTITION WITH CENTER OF HISTORIC SKYLIGHT MULLION ABOVE.
- NEW 3X3 ACCESS DOOR W/ 3-HR RATING @ WALL TO ABANDONED MECHANICAL TUNNEL.
- NEW CONCRETE SLAB AT EXISTING STOOP TO MATCH FLOOR HEIGHT AT BUILDING 7. SEE STRUCTURAL.
- EXISTING WOOD STAIR, GUARD AND HANDRAIL TO REMAIN. REPAIR/REPLACE MISSING BEAD BOARD HANDRAIL SUPPORT AND STAIR RUN FROM LEVEL 01 TO 1ST LANDING TO MATCH EXISTING HISTORIC CONDITION PERCENT. PROVIDE NEW STEEL HANDRAILS AT EXISTING CMU WALLS. PREP ALL SURFACES FOR NEW PAINT.
- EXISTING CONCRETE STAIR, CMU GUARD WALL AND HANDRAIL TO REMAIN. PREP ALL SURFACES FOR NEW FINISHES.
- PROVIDE NEW EGRESS BARRIER GATE AT EXISTING STEEL GUARDRAIL. EXISTING CONCRETE STAIR, STEEL GUARDRAIL AND HANDRAIL TO REMAIN. PREP ALL SURFACES FOR NEW FINISHES.
- NEW CHALKLINE FENCE, GATES AND PRIVACY SLATS.
- BUILD TYPE P6 UNIT DEMISING WALL WITH RESILIENT CHANNEL ON THIS SIDE.
- TAPER GYPCRETE TOPPING 1:20 SLOPE MAX TO MEET EXISTING FINISH LEVEL AT TRANSITION AREA TO STAIRS OR BETWEEN BUILDINGS.
- NEW TAPERED POLISHED EPOXY FLOOR TOPPING TO TRANSITION FLOOR FINISH LEVEL CHANGE BETWEEN BUILDINGS 6 & 7. TAPER 1:20 SLOPE MAX.
- PATCH AND REPAIR DAMAGED AND MISSING EXTERIOR STUCCO TO MATCH ADJACENT SURFACE.

**GENERAL FLOOR PLAN NOTES TO CONTRACTOR**

- THIS DRAWING IS FURTHER SUPPORTED BY INFORMATION CONTAINED IN THE SPECIFICATION MANUAL.
- THE CIVIL, STRUCTURAL, MECHANICAL, ELECTRICAL, PLUMBING, FIRE PROTECTION, AUDIO-VISUAL, AND SECURITY DRAWINGS ARE SUPPLEMENTARY TO THE ARCHITECTURAL DRAWINGS. IT SHALL BE THE RESPONSIBILITY OF THE CONTRACTOR TO COORDINATE THE INFORMATION CONTAINED IN ALL THE DRAWINGS BEFORE THE INSTALLATION OF ALL WORK.
- DO NOT SCALE DRAWINGS. CONTRACTOR TO VERIFY ALL CONDITIONS AND DIMENSIONS AT THE JOB SITE PRIOR TO COMMENCING CONSTRUCTION.
- FLOOR ELEVATIONS ARE TO THE TOP OF THE SUB-FLOOR MATERIAL UNLESS OTHERWISE NOTED.
- CONTRACTORS SHALL JOINTLY PROVIDE AND INSTALL ALL STIFFENERS, BRACING, BACKING PLATES, WALL BLOCKING AND SUPPORTING BRACKETS REQUIRED FOR THE INSTALLATION OF CASEWORK, TOILET ACCESSORIES, PARTITIONS, MILLWORK, AND ALL WORK MOUNTED OR SUSPENDED BY ALL TRADES.

**NEW WORK PLAN LEGEND**

- EXISTING TO REMAIN
- MASONRY PARTITION. SEE PARTITION TYPES FOR DETAILS
- METAL STUD PARTITION. SEE PARTITION TYPES FOR DETAILS TYPE
- METAL STUD PARTITION. SEE PARTITION TYPES FOR DETAILS TYPE
- NEW WORK KEY NOTE

**PATCH AND INFILL LEGEND**

- CONCRETE FLOOR OPENING INFILL. SEE STRUCTURAL FOR INFILL CONDITIONS. V.I.F. EXACT SIZE AND LOCATIONS.
- CONCRETE FLOOR COSMETIC PATCH. V.I.F. EXACT SIZE AND LOCATIONS.
- WOOD FLOOR STRUCTURAL INFILL. SEE STRUCTURAL FOR INFILL CONDITIONS. V.I.F. EXACT SIZE AND LOCATIONS.

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SHEET TITLE  
NEW WORK PLAN - LEVEL 02 - BUILDINGS 8A & 8B

REVISIONS  
1 10/09/20 ADDENDUM #1


SCALE VARIES

PROJECT NUMBER 200102


SET TYPE CONSTRUCTION DOCUMENTS

DATE ISSUED 9/25/20

SHEET NUMBER A222W

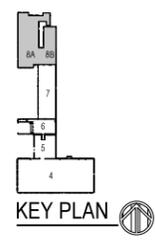

1 NEW WORK PLAN - LEVEL 02 - BUILDING 8A & 8B  
Scale: 1/8" = 1'-0"

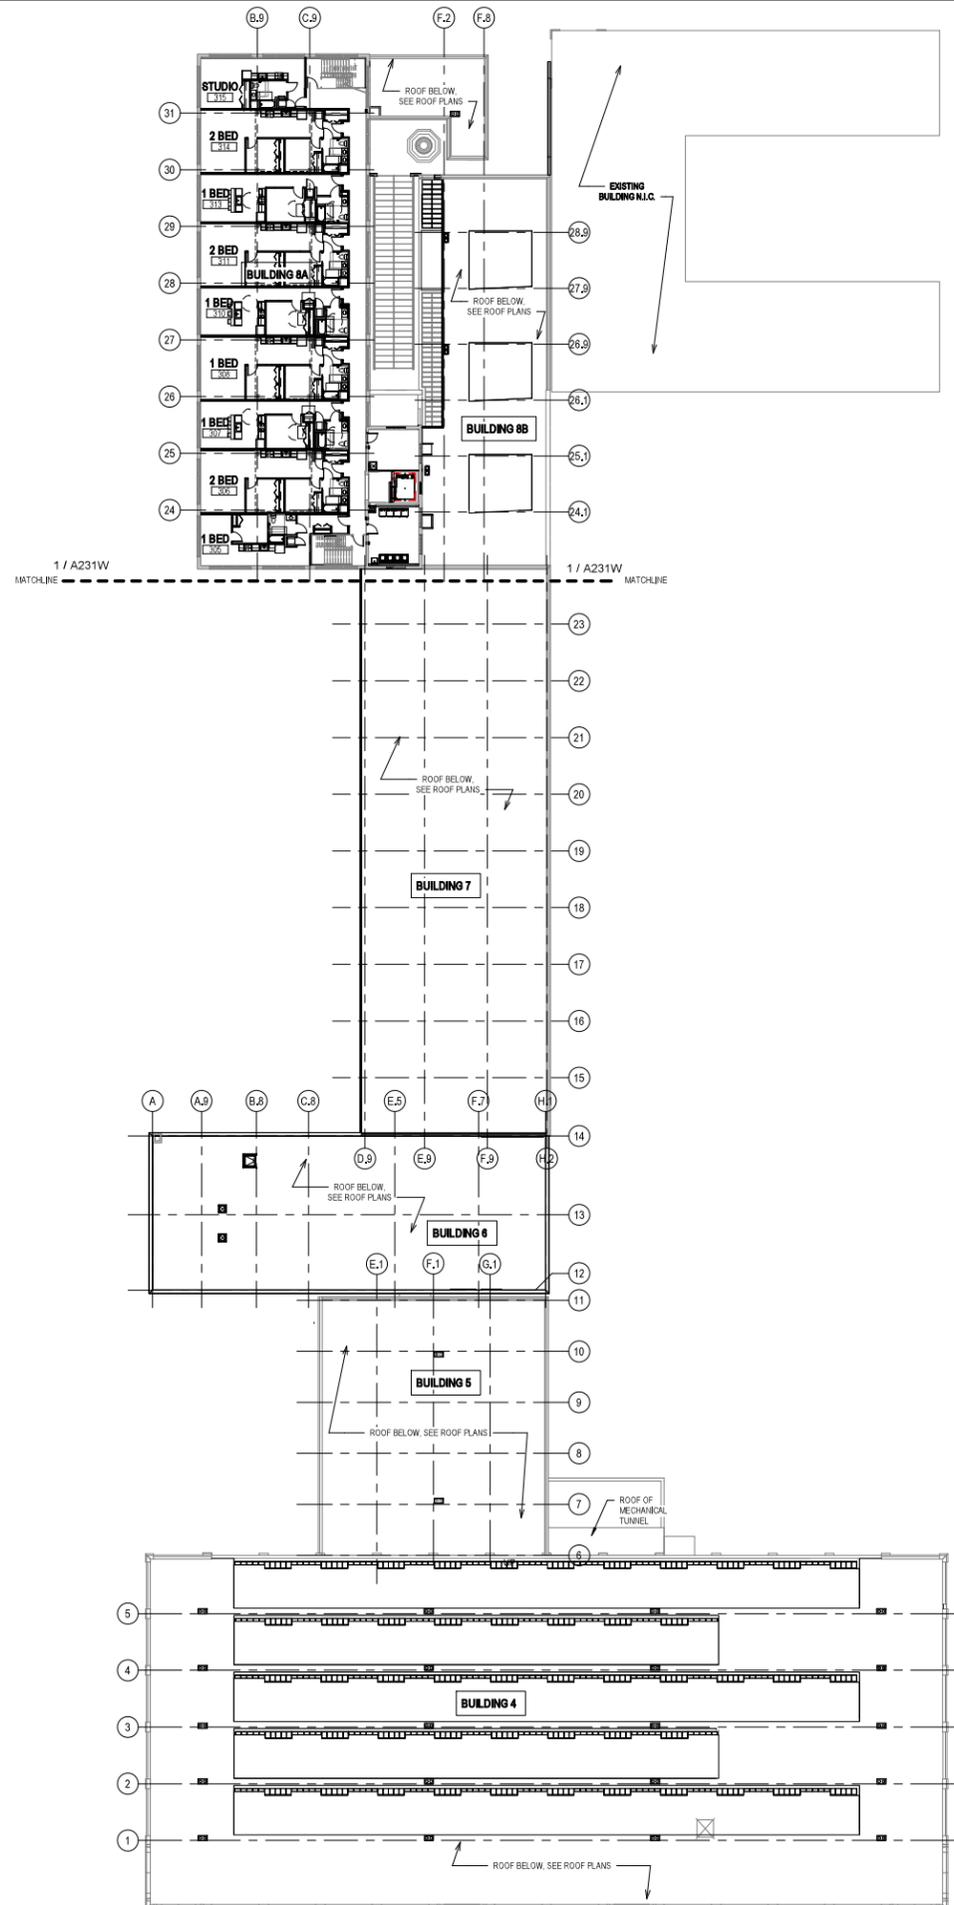

**1 NEW WORK PLAN - LEVEL 03 - OVERVIEW**

Scale: 3/8" = 1'-0"  
 0' 2.65' 5.3' 8'


**NEW WORK PLAN KEY NOTES - 1/8" PLANS**

- SEE PROJECT GENERAL CONDITIONS, GENERAL INFORMATION ON SHEET A001W AND SELECTIVE DEMOLITION, CUTTING AND PATCHING SPECIFICATIONS THAT ARE USED IN ASSOCIATION WITH THESE NOTES.
- NEW WORK PLAN KEY NOTES APPLY TO ALL 1/8" NEW WORK DRAWINGS AND MAY NOT BE USED ON EVERY SHEET.
- 001 SEE UNIT 137 ENLARGED PLAN.
  - 002 SEE UNIT 105 ENLARGED PLAN.
  - 003 SEE UNIT 113 ENLARGED PLAN.
  - 004 SEE UNIT 118 ENLARGED PLAN. UNIT MAY BE MIRRORED.
  - 005 SEE UNIT 149 ENLARGED PLAN.
  - 006 SEE UNIT 131 ENLARGED PLAN.
  - 007 SEE UNIT 132 ENLARGED PLAN.
  - 008 SEE UNIT 223 ENLARGED PLAN.
  - 009 SEE UNIT 251 ENLARGED PLAN.
  - 010 SEE UNIT 148 ENLARGED PLAN.
  - 011 SEE UNIT 151 ENLARGED PLAN.
  - 012 SEE UNIT 225 ENLARGED PLAN.
  - 013 SEE UNIT 242 ENLARGED PLAN.
  - 014 SEE UNIT 128 ENLARGED PLAN. UNIT MAY BE MIRRORED.
  - 015 SEE UNIT 122 ENLARGED PLAN.
  - 016 SEE UNIT 221 ENLARGED PLAN.
  - 017 SEE UNIT 111 ENLARGED PLAN.
  - 018 SEE UNIT 217 ENLARGED PLAN.
  - 019 SEE UNIT 124 ENLARGED PLAN.
  - 020 SEE UNIT 224 ENLARGED PLAN.
  - 021 SEE UNIT 223 ENLARGED PLAN.
  - 022 SEE UNIT 109 ENLARGED PLAN.
  - 023 SEE UNIT 115 ENLARGED PLAN.
  - 024 SEE UNIT 130 ENLARGED PLAN. UNIT MAY BE MIRRORED.
  - 025 SEE UNIT 215 ENLARGED PLAN.
  - 026 SEE UNIT 205 ENLARGED PLAN.
  - 027 SEE UNIT 314 ENLARGED PLAN.
  - 028 SEE UNIT 139 ENLARGED PLAN.
  - 029 SEE UNIT 140 ENLARGED PLAN.
  - 030 SEE UNIT 201 ENLARGED PLAN.
  - 031 SEE UNIT 213 ENLARGED PLAN. UNIT TO INCLUDE AUDIO AND VISUAL ALARM DEVICES FOR THE HEARING AND VISUALLY IMPAIRED. COORDINATE LOCATION WITH ELECTRICAL DRAWINGS.
  - 032 SEE UNIT 141 ENLARGED PLAN.
  - 033 SEE UNIT 127 ENLARGED PLAN.
  - 034 SEE UNIT 206 ENLARGED PLAN.
  - 035 NEW CONCRETE ON METAL DECK INFILL WITH SPRAY-APPLIED FIRE RESISTIVE MATERIAL AT NEW STEEL BEAMS AND ANGLES TO MAINTAIN FLOOR ASSEMBLY FIRE RATING. SEE OVERVIEW FLOOR PLANS FOR REQUIRED FLOOR ASSEMBLY FIRE RATINGS. SEE STRUCTURAL FOR DETAIL.
  - 036 NEW CONCRETE INFILL AT EXISTING PIT MATCH ADJACENT FLOOR LEVEL, FINISH AND SURFACE TEXTURE.
  - 037 PATCH AND REPAIR DAMAGED CONCRETE SLAB MATCH ADJACENT FLOOR LEVEL, FINISH AND SURFACE TEXTURE.
  - 038 NEW TIMBER FLOOR DECK INFILL TO MATCH EXISTING. SEE STRUCTURAL.
  - 039 NEW CONCRETE INFILL SLAB AT EXISTING SUNKEN STAR PIT. MATCH ADJACENT FLOOR LEVEL, FINISH AND SURFACE TEXTURE.
  - 040 PATCH & REPAIR CONCRETE SLAB WHERE EMBEDDED METAL PLATES AND/OR METAL TRENCH COVERS WERE REMOVED. FILL AND LEVEL WITH NEW CONCRETE TO MATCH ADJACENT SURFACE LEVEL AND FINISH TEXTURE. FEATHER CONCRETE TO LEVEL AT EXISTING METAL FLOOR OPENING FRAMES IF PRESENT.
  - 041 NEW INFILL WALL & PRECAST SILL TO REBUILD WINDOW OPENING. SEE ELEVATIONS. TOOTH IN SALVAGED BRICK WITH NEW MORTAR TO MATCH ADJACENT HISTORIC MASONRY.
  - 042 NEW INFILL WALL TO REBUILD WINDOW & DOOR OPENING. TOOTH IN SALVAGED MASONRY WITH NEW MORTAR TO MATCH ADJACENT HISTORIC MASONRY PARSE SURFACES TO MATCH ADJACENT HISTORIC PARSE IF PRESENT.
  - 043 NEW PARTIAL INFILL WALL ASSEMBLY TO REBUILD OPENING IN EXISTING WALL BELOW SILL AT FLOOR LEVEL. SEE ELEVATIONS. TOOTH IN SALVAGED BRICK WITH NEW MORTAR TO MATCH ADJACENT HISTORIC MASONRY. SEE DETAIL 71AS10W FOR WALL ASSEMBLY.
  - 044 PATCH & REPAIR DAMAGED WALL OPENING AT SILL. TOOTH IN SALVAGED BRICK WITH NEW MORTAR AND PROVIDE NEW SILL TO MATCH ADJACENT HISTORIC MASONRY.
  - 045 PATCH & REPAIR DAMAGED AND MISSING PLASTER RETURNS AT JAMB, HEAD AND SILL TO MATCH EXISTING RETURNS. SEE WINDOW DETAILS. AT THESE WALLS THERE WILL BE A FURRING WITH 3/8" GWB EXTENDING FROM FLOOR TO TOP OF WALL AT UNDERSIDE OF STRUCTURE.
  - 046 PATCH & REPAIR DAMAGED AND MISSING PLASTER WOOD LATH FURRING WALL. PATCH AND REPAIR EXISTING RADICUSED PLASTER RETURN PROFILES IF DAMAGED AT JAMB, HEAD AND SILL TO MATCH EXISTING RETURNS AT ADJACENT WINDOWS OF THE SAME TYPE.
  - 047 NEW GYPSUM BOARD INFILL WALL ASSEMBLY AT EXISTING OPENING. SEE DETAIL 11A10W.
  - 048 NEW CMU INFILL WALL ASSEMBLY AT EXISTING OPENING. SEE DETAIL 2A10W.
  - 049 NEW GYPSUM BOARD INFILL WALL ASSEMBLY AT EXISTING NON-HISTORIC WALL OPENING. MATCH EXISTING WALL ASSEMBLY WIDTH AND ADJACENT SURFACE FINISH.
  - 050 NEW METAL PANEL INFILL WALL ASSEMBLY AT EXISTING EXTERIOR MASONRY WALL OPENING. SEE DETAIL 51AS10W.

**NEW WORK PLAN KEY NOTES - 1/8" PLANS**

- SEE PROJECT GENERAL CONDITIONS, GENERAL INFORMATION ON SHEET A001W AND SELECTIVE DEMOLITION, CUTTING AND PATCHING SPECIFICATIONS THAT ARE USED IN ASSOCIATION WITH THESE NOTES.
- NEW WORK PLAN KEY NOTES APPLY TO ALL 1/8" NEW WORK DRAWINGS AND MAY NOT BE USED ON EVERY SHEET.
- 051 NEW METAL PANEL INFILL WALL ASSEMBLY AT EXISTING WINDOW OPENING. SEE DETAIL 4A10W.
  - 052 EXISTING HISTORIC SLIDING FIRE DOOR ASSEMBLY TO REMAIN. SECURE SLIDING DOOR IN A FULLY OPEN POSITION WITH METAL Z-BRACKETS. PREPARE ENTIRE ASSEMBLY FOR PAINTED FINISH.
  - 053 EXISTING HISTORIC SLIDING FIRE DOOR ASSEMBLY TO REMAIN. SECURE SLIDING DOOR IN A CLOSED POSITION WITH METAL Z-BRACKETS. PREPARE ENTIRE ASSEMBLY FOR NEW PAINTED FINISH.
  - 054 REINSTALL SALVAGED HISTORIC SLIDING FIRE DOOR ASSEMBLY AND HARDWARE FROM THIS OPENING TO NEW ORIENTATION AS SHOWN. SECURE SLIDING DOOR IN A CLOSED POSITION WITH METAL Z-BRACKETS. PREPARE ENTIRE ASSEMBLY FOR NEW PAINTED FINISH.
  - 055 EXISTING HISTORIC COLONNAD OVERHEAD DOOR ASSEMBLY TO REMAIN. SECURE COLONNAD DOOR IN A FULLY OPEN POSITION. PREPARE ENTIRE ASSEMBLY FOR PAINTED FINISH.
  - 056 EXISTING HISTORIC COLONNAD OVERHEAD DOOR ASSEMBLY TO REMAIN. SECURE COLONNAD DOOR IN A FULLY CLOSED POSITION. PREPARE ENTIRE ASSEMBLY FOR PAINTED FINISH.
  - 057 EXISTING HISTORIC OVERHEAD DOOR ASSEMBLY TO REMAIN. REPAIR TRACK AND HARDWARE TO RETURN DOOR TO OPERATING CONDITION. PREPARE ENTIRE ASSEMBLY FOR PAINTED FINISH.
  - 058 EXISTING STEEL SASH WINDOW ASSEMBLY TO REMAIN. PREPARE ENTIRE ASSEMBLY FOR PAINTED FINISH. REPLACE BROKEN OR MISSING PANE OF GLASS WITH NEW GLASS TO MATCH EXISTING.
  - 059 NEW OPENING IN EXISTING CMU WALL. TOOTH IN NEW CMU AND MORTAR TO MATCH EXISTING.
  - 060 EXISTING GLAZED WALL TILE TO REMAIN. PROTECT DURING CONSTRUCTION.
  - 061 TUCKPOINT AND REPAIR EXISTING CHIMNEY TO MATCH EXISTING MATERIALS. SEE EXTERIOR MASONRY REPORT AND DRAWINGS.
  - 062 EXISTING WOOD SINGLE HUNG WINDOW FRAME, SASH AND ALL CASING/TRIM TO REMAIN. PREPARE EXISTING INTERIOR & EXTERIOR SURFACES FOR NEW PAINT. REPLACE MISSING AND/OR BROKEN GLASS TO MATCH EXISTING AND INSTALL NEW GLAZING PUTTY AT ALL PANEALS. INSTALL NEW INTERIOR STORM WINDOWS. SEE DETAIL 13AS10W.
  - 063 ALIGN EDGE OF DEMISING WALL WITH EDGE OF HISTORIC MASONRY OPENING.
  - 064 ALIGN CENTER OF DEMISING WALL OR PARTITION WITH CENTERLINE OF HISTORIC COLUMN, OR BEAM ABOVE.
  - 065 ALIGN EDGE OF DEMISING WALL WITH EDGE OF HISTORIC CONCRETE DROP SLAB.
  - 066 ALIGN CENTER OF DEMISING WALL PARTITION WITH CENTERLINE OF WINDOW MULLION.
  - 067 ALIGN EDGE OF DEMISING WALL WITH OUTER EDGE OF LIGHT MONITOR VOLUME.
  - 068 ALIGN CENTER OF DEMISING WALL OR PARTITION WITH CENTER OF HISTORIC SKYLIGHT MULLION ABOVE.
  - 069 NEW 3X3 ACCESS DOOR W/ 3-HR RATING @ WALL TO ABANDONED MECHANICAL TUNNEL.
  - 070 NEW CONCRETE SLAB AT EXISTING STOOP TO MATCH FLOOR HEIGHT AT BUILDING 7. SEE STRUCTURAL.
  - 071 EXISTING WOOD STAIR, GUARD AND HANDRAIL TO REMAIN. PREP ALL SURFACES FOR NEW PAINT.
  - 072 EXISTING WOOD STAIR, GUARD AND HANDRAIL TO REMAIN. REPAIR/REPLACE MISSING BEAD BOARD HANDRAIL SUPPORT AND STAIR RUN FROM LEVEL 01 TO 1ST LANDING TO MATCH EXISTING HISTORIC CONDITION PERCENT. PROVIDE NEW STEEL HANDRAILS AT EXISTING CMU WALLS. PREP ALL SURFACES FOR NEW PAINT.
  - 073 EXISTING CONCRETE STAIR, CMU GUARD WALL AND HANDRAIL TO REMAIN. PREP ALL SURFACES FOR NEW FINISHES.
  - 074 PROVIDE NEW EGRESS BARRIER GATE AT EXISTING STEEL GUARDRAIL. EXISTING CONCRETE STAIR, STEEL GUARDRAIL AND HANDRAIL TO REMAIN. PREP ALL SURFACES FOR NEW FINISHES.
  - 075 NEW CHAIN LINK STAIR AND PRIVACY SLATS.
  - 076 BUILD TYPE P6 UNIT DEMISING WALL WITH RESILIENT CHANNEL ON THIS SIDE.
  - 077 TAPER GYPCRETE TOPPING 1:20 SLOPE MAX. TO MEET EXISTING FINISH LEVEL AT TRANSITION AREA TO STAIRS OR BETWEEN BUILDINGS.
  - 078 NEW TAPERED POLISHED EPOXY FLOOR TOPPING TO TRANSITION FLOOR FINISH LEVEL CHANGE BETWEEN BUILDINGS 6 & 7. TAPER 1:20 SLOPE MAX.
  - 079 PATCH AND REPAIR DAMAGED AND MISSING EXTERIOR STUCCO TO MATCH ADJACENT SURFACE.

- GENERAL FLOOR PLAN NOTES TO CONTRACTOR**
- THIS DRAWING IS FURTHER SUPPORTED BY INFORMATION CONTAINED IN THE SPECIFICATION MANUAL.
  - THE CIVIL, STRUCTURAL, MECHANICAL, ELECTRICAL, PLUMBING, FIRE PROTECTION, AUDIO-VISUAL, AND SECURITY DRAWINGS ARE SUPPLEMENTARY TO THE ARCHITECTURAL DRAWINGS. IT SHALL BE THE RESPONSIBILITY OF THE CONTRACTOR TO COORDINATE THE INFORMATION CONTAINED IN ALL THE DRAWINGS BEFORE THE INSTALLATION OF ALL WORK.
  - DO NOT SCALE DRAWINGS. CONTRACTOR TO VERIFY ALL CONDITIONS AND DIMENSIONS AT THE JOB SITE PRIOR TO COMMENCING CONSTRUCTION.
  - FLOOR ELEVATIONS ARE TO THE TOP OF THE SUB-FLOOR MATERIAL, UNLESS OTHERWISE NOTED.
  - CONTRACTORS SHALL JOINTLY PROVIDE AND INSTALL ALL STIFFENERS, BRACING, BANDING PLATES, WALL BLOCKING AND SUPPORTING BRACKETS REQUIRED FOR THE INSTALLATION OF CASEWORK, TOILET ACCESSORIES, PARTITIONS, MILLWORK, AND ALL WORK MOUNTED OR SUSPENDED BY ALL TRADES.

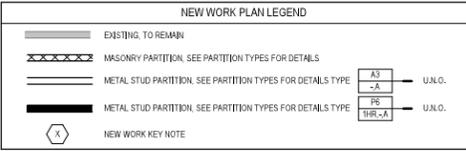

FLOOR ASSEMBLY SUMMARY			
	LEVEL 01	LEVEL 02	LEVEL 03
BLDG. 4 MAIN AREA	EXISTING CONCRETE SLAB-ON-GRADE		
BLDG. 4 AT PARTIAL BASEMENT	EXISTING 6" CONCRETE SLAB -ASSEMBLY FIRE RATING 1 HOUR		
BLDG. 5	EXISTING CONCRETE SLAB-ON-GRADE		
BLDG. 6	EXISTING 10 1/2" CONCRETE SLAB -ASSEMBLY FIRE RATING 1 HOUR -STC-RIC RATING	EXISTING 10 1/2" CONCRETE SLAB -ASSEMBLY FIRE RATING 1 HOUR -STC-RIC RATING	
BLDG. 7	EXISTING CONCRETE SLAB-ON-GRADE	-FINISH FLOORING (SEE FINISH PLANS FOR MATERIALS AND LOCATIONS OF FINISH MATERIALS) -NEW 1-1/2" GYPSUM CEMENT UNDERLAYMENT -NEW ACOUSTIC SOUND MAT (AT NON-CARPETED AREAS ONLY) -EXISTING 2" TIMBER SUBFLOORING -EXISTING 7X13 TIMBER FLOOR JOISTS (NDS CH. 16 CALCULATED CHAR RATE MEETS 12-HOUR RATING) -UNDERSIDE OF EXISTING WOOD SUBFLOORING TO RECEIVE NEW INTUMESCENT COATING. -ASSEMBLY FIRE RATING: 12 HOUR -FSTC: 45-49 FRC: 45-47	
BLDG. 8A	-FINISH FLOORING (SEE FINISH PLANS FOR MATERIALS AND LOCATIONS OF FINISH MATERIALS) -EXISTING CONCRETE SLAB ON GRADE	-FINISH FLOORING (SEE FINISH PLANS FOR MATERIALS AND LOCATIONS OF FINISH MATERIALS) -NEW 1-1/2" GYPSUM CEMENT UNDERLAYMENT -NEW ACOUSTIC SOUND MAT (AT NON-CARPETED AREAS ONLY) -EXISTING 2" TIMBER SUBFLOORING -EXISTING 7X13 TIMBER FLOOR JOISTS (NDS CH. 16 CALCULATED CHAR RATE MEETS 12-HOUR RATING) -ASSEMBLY FIRE RATING: 12 HOUR -FSTC: 45-49 FRC: 45-47	-FINISH FLOORING (SEE FINISH PLANS FOR MATERIALS AND LOCATIONS OF FINISH MATERIALS) -NEW 1-1/2" GYPSUM CEMENT UNDERLAYMENT -NEW ACOUSTIC SOUND MAT (AT NON-CARPETED AREAS ONLY) -EXISTING 2" TIMBER SUBFLOORING (NDS CH. 16 CALCULATED CHAR RATE MEETS 12-HOUR RATING) -EXISTING 6X14 TIMBER FLOOR JOIST (NDS CH. 16 CALCULATED CHAR RATE MEETS 12-HOUR RATING) -ASSEMBLY FIRE RATING: 12 HOUR -FSTC: 45-49 FRC: 45-47
BLDG. 8A @ ELEVATOR CORE	EXISTING CONCRETE SLAB-ON-GRADE	EXISTING 3" CONCRETE SLAB -EXISTING 10" CLAY TILE INFILL -ASSEMBLY FIRE RATING 1 HOUR	EXISTING 3" CONCRETE SLAB -EXISTING 10" CLAY TILE INFILL -ASSEMBLY FIRE RATING 1 HOUR
BLDG. 8B	EXISTING CONCRETE SLAB-ON-GRADE	-FINISH FLOORING (SEE FINISH PLANS FOR MATERIALS AND LOCATIONS OF FINISH MATERIALS) -NEW 1-1/2" GYPSUM CEMENT UNDERLAYMENT -NEW ACOUSTIC SOUND MAT (AT NON-CARPETED AREAS ONLY) -EXISTING 2" TIMBER SUBFLOORING -EXISTING 6X14 TIMBER FLOOR JOIST (NDS CH. 16 CALCULATED CHAR RATE MEETS 12-HOUR RATING) -ASSEMBLY FIRE RATING: 12 HOUR -FSTC: 45-49 FRC: 45-47	




CONSULTANTS


COMMUNITY WITHIN THE CORRIDOR - WEST BLOCK  
 2758 N. 38RD STREET  
 MILWAUKEE, WI 53210  
 SHEET TITLE  
**NEW WORK PLAN - LEVEL 03 - OVERVIEW ALL BUILDINGS**

REVISIONS  
**1 10/09/20 ADDENDUM #1**

SCALE	VARES
PROJECT NUMBER	200102
SET TYPE	CONSTRUCTION DOCUMENTS
DATE ISSUED	9/25/20
SHEET NUMBER	<b>A230W</b>

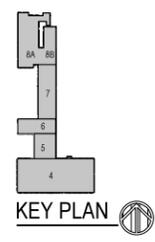

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**NEW WORK PLAN KEY NOTES - 1/8" PLANS**

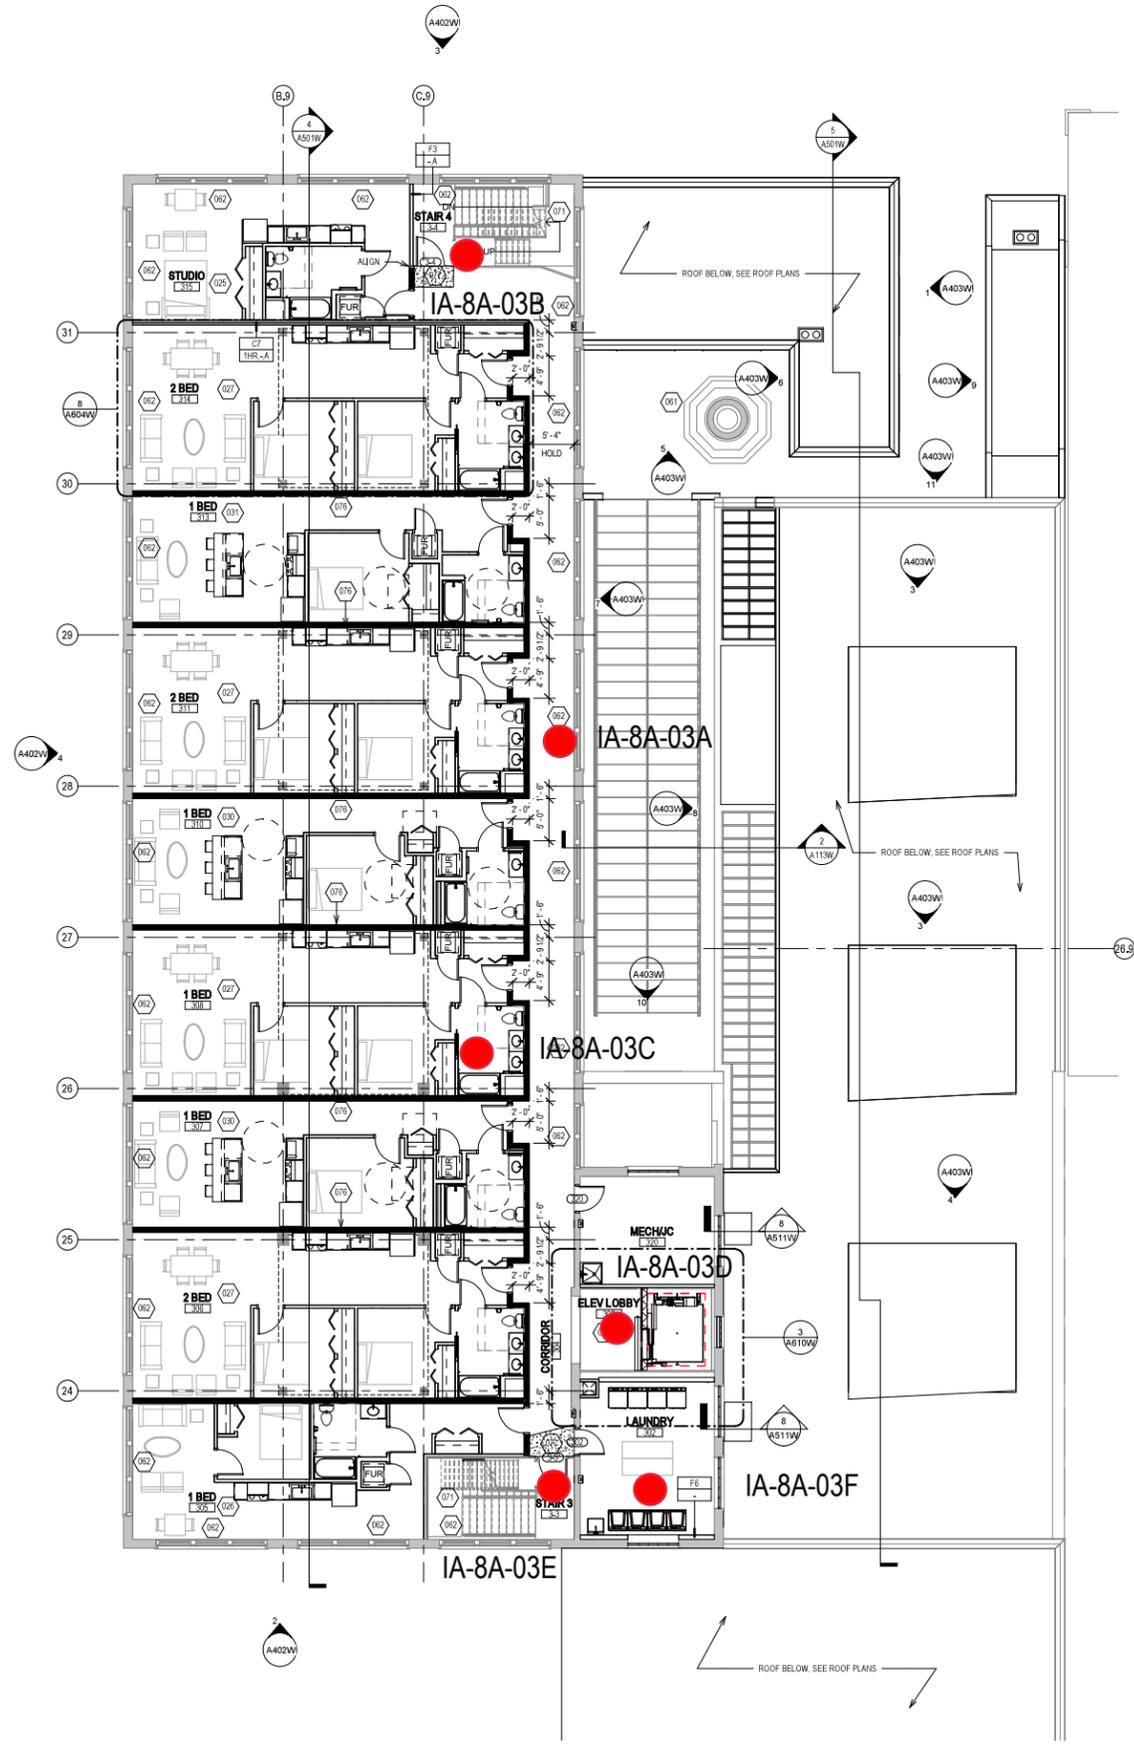- SEE PROJECT GENERAL CONDITIONS, GENERAL INFORMATION ON SHEET A001W AND SELECTIVE DEMOLITION, CUTTING AND PATCHING SPECIFICATIONS THAT ARE USED IN ASSOCIATION WITH THESE NOTES.
- NEW WORK PLAN KEY NOTES APPLY TO ALL 1/8" NEW WORK DRAWINGS AND MAY NOT BE USED ON EVERY SHEET.
- 001 SEE UNIT 137 ENLARGED PLAN.
  - 002 SEE UNIT 105 ENLARGED PLAN.
  - 003 SEE UNIT 115 ENLARGED PLAN.
  - 004 SEE UNIT 18 ENLARGED PLAN. UNIT MAY BE MIRRORED.
  - 005 SEE UNIT 149 ENLARGED PLAN.
  - 006 SEE UNIT 131 ENLARGED PLAN.
  - 007 SEE UNIT 132 ENLARGED PLAN.
  - 008 SEE UNIT 232 ENLARGED PLAN.
  - 009 SEE UNIT 251 ENLARGED PLAN.
  - 010 SEE UNIT 148 ENLARGED PLAN.
  - 011 SEE UNIT 151 ENLARGED PLAN.
  - 012 SEE UNIT 225 ENLARGED PLAN.
  - 013 SEE UNIT 242 ENLARGED PLAN.
  - 014 SEE UNIT 128 ENLARGED PLAN. UNIT MAY BE MIRRORED.
  - 015 SEE UNIT 122 ENLARGED PLAN.
  - 016 SEE UNIT 221 ENLARGED PLAN.
  - 017 SEE UNIT 111 ENLARGED PLAN.
  - 018 SEE UNIT 217 ENLARGED PLAN.
  - 019 SEE UNIT 124 ENLARGED PLAN.
  - 020 SEE UNIT 224 ENLARGED PLAN.
  - 021 SEE UNIT 223 ENLARGED PLAN.
  - 022 SEE UNIT 109 ENLARGED PLAN.
  - 023 SEE UNIT 118 ENLARGED PLAN.
  - 024 SEE UNIT 133 ENLARGED PLAN. UNIT MAY BE MIRRORED.
  - 025 SEE UNIT 215 ENLARGED PLAN.
  - 026 SEE UNIT 205 ENLARGED PLAN.
  - 027 SEE UNIT 314 ENLARGED PLAN.
  - 028 SEE UNIT 139 ENLARGED PLAN.
  - 029 SEE UNIT 140 ENLARGED PLAN.
  - 030 SEE UNIT 207 ENLARGED PLAN.
  - 031 SEE UNIT 213 ENLARGED PLAN. UNIT TO INCLUDE AUDIO AND VISUAL ALARM DEVICES FOR THE HEARING AND VISUALLY IMPAIRED. COORDINATE LOCATION WITH ELECTRICAL DRAWINGS.
  - 032 SEE UNIT 147 ENLARGED PLAN.
  - 033 SEE UNIT 127 ENLARGED PLAN.
  - 034 SEE UNIT 206 ENLARGED PLAN.
  - 035 NEW CONCRETE ON METAL DECK INFILL WITH SPRAY-APPLIED FIRE RESISTIVE MATERIAL AT NEW STEEL BEAMS AND ANGLES TO MAINTAIN FLOOR ASSEMBLY FIRE RATING. SEE OVERVIEW FLOOR PLANS FOR REQUIRED FLOOR ASSEMBLY FIRE RATINGS. SEE STRUCTURAL FOR DETAIL.
  - 036 NEW CONCRETE INFILL AT EXISTING PIT MATCH ADJACENT FLOOR LEVEL, FINISH AND SURFACE TEXTURE.
  - 037 PATCH AND REPAIR DAMAGED CONCRETE SLAB MATCH ADJACENT FLOOR LEVEL, FINISH AND SURFACE TEXTURE.
  - 038 NEW TIMBER FLOOR DECK INFILL TO MATCH EXISTING. SEE STRUCTURAL.
  - 039 NEW CONCRETE INFILL SLAB AT EXISTING SUNKEN STAIR PIT MATCH ADJACENT FLOOR LEVEL, FINISH AND SURFACE TEXTURE.
  - 040 PATCH & REPAIR CONCRETE SLAB WHERE EMBEDDED METAL PLATES AND/OR METAL TRENCH COVERS WERE REMOVED. FILL AND LEVEL WITH NEW CONCRETE TO MATCH ADJACENT SURFACE LEVEL AND FINISH TEXTURE. FEATHER CONCRETE TO LEVEL AT EXISTING METAL FLOOR OPENING FRAMES IF PRESENT.
  - 041 NEW INFILL WALL & PRECAST SILL TO REBUILD WINDOW OPENING. SEE ELEVATIONS. TOOTH IN SALVAGED BRICK WITH NEW MORTAR TO MATCH ADJACENT HISTORIC MASONRY.
  - 042 NEW INFILL WALL TO REBUILD WINDOW & DOOR OPENING. TOOTH IN SALVAGED MASONRY WITH NEW MORTAR TO MATCH ADJACENT HISTORIC MASONRY. PARGE SURFACES TO MATCH ADJACENT HISTORIC PARGE IF PRESENT.
  - 043 NEW PARTIAL INFILL WALL ASSEMBLY TO REBUILD OPENING IN EXISTING WALL BELOW SILL AT FLOOR LEVEL. SEE ELEVATIONS. TOOTH IN SALVAGED BRICK WITH NEW MORTAR TO MATCH ADJACENT HISTORIC MASONRY. SEE DETAIL 71A510W FOR WALL ASSEMBLY.
  - 044 PATCH & REPAIR DAMAGED WALL OPENING AT SILL. TOOTH IN SALVAGED BRICK WITH NEW MORTAR AND PROVIDE NEW SILL TO MATCH ADJACENT HISTORIC MASONRY.
  - 045 PATCH & REPAIR DAMAGED AND MISSING PLASTER WOOD LATH FURRING WALL. PATCH AND REPAIR EXISTING RADICUSED PLASTER RETURN PROFILES IF DAMAGED AT JAMB, HEAD AND SILL TO MATCH EXISTING RETURNS. SEE WINDOW DETAILS. AT THESE WALLS THERE WILL BE A FURRING WITH 3/8" GWB EXTENDING FROM FLOOR TO TOP OF WALL AT UNDERSIDE OF STRUCTURE.
  - 046 PATCH & REPAIR DAMAGED AND MISSING PLASTER WOOD LATH FURRING WALL. PATCH AND REPAIR EXISTING RADICUSED PLASTER RETURN PROFILES IF DAMAGED AT JAMB, HEAD AND SILL TO MATCH EXISTING RETURNS AT ADJACENT WINDOWS OF THE SAME TYPE.
  - 047 NEW GYPSUM BOARD INFILL WALL ASSEMBLY AT EXISTING OPENING. SEE DETAIL 11A710W.
  - 048 NEW CMU INFILL WALL ASSEMBLY AT EXISTING OPENING. SEE DETAIL 2A710W.
  - 049 NEW GYPSUM BOARD INFILL WALL ASSEMBLY AT EXISTING NON-HISTORIC WALL OPENING. MATCH EXISTING WALL ASSEMBLY WIDTH AND ADJACENT SURFACE FINISH.
  - 050 NEW METAL PANEL INFILL WALL ASSEMBLY AT EXISTING EXTERIOR MASONRY WALL OPENING. SEE DETAIL 5A510W.

**NEW WORK PLAN KEY NOTES - 1/8" PLANS**

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  - 052 EXISTING HISTORIC SLIDING FIRE DOOR ASSEMBLY TO REMAIN. SECURE SLIDING DOOR IN A FULLY OPEN POSITION WITH METAL Z-BRACKETS. PREPARE ENTIRE ASSEMBLY FOR PAINTED FINISH.
  - 053 EXISTING HISTORIC SLIDING FIRE DOOR ASSEMBLY TO REMAIN. SECURE SLIDING DOOR IN A CLOSED POSITION WITH METAL Z-BRACKETS. PREPARE ENTIRE ASSEMBLY FOR NEW PAINTED FINISH.
  - 054 REINSTALL SALVAGED HISTORIC SLIDING FIRE DOOR ASSEMBLY AND HARDWARE FROM THIS OPENING TO NEW ORIENTATION AS SHOWN. SECURE SLIDING DOOR IN A CLOSED POSITION WITH METAL Z-BRACKETS. PREPARE ENTIRE ASSEMBLY FOR NEW PAINTED FINISH.
  - 055 EXISTING HISTORIC COILING OVERHEAD DOOR ASSEMBLY TO REMAIN. SECURE COILING DOOR IN A FULLY OPEN POSITION. PREPARE ENTIRE ASSEMBLY FOR PAINTED FINISH.
  - 056 EXISTING HISTORIC COILING OVERHEAD DOOR ASSEMBLY TO REMAIN. SECURE COILING DOOR IN A FULLY CLOSED POSITION. PREPARE ENTIRE ASSEMBLY FOR PAINTED FINISH.
  - 057 EXISTING HISTORIC OVERHEAD DOOR ASSEMBLY TO REMAIN. REPAIR TRACK AND HARDWARE TO RETURN DOOR TO OPERATING CONDITION. PREPARE ENTIRE ASSEMBLY FOR PAINTED FINISH.
  - 058 EXISTING STEEL SASH WINDOW ASSEMBLY TO REMAIN. PREPARE ENTIRE ASSEMBLY FOR PAINTED FINISH. REPLACE BROKEN OR MISSING PANE OF GLASS WITH NEW GLASS TO MATCH EXISTING.
  - 059 NEW OPENING IN EXISTING CMU WALL. TOOTH IN NEW CMU AND MORTAR TO MATCH EXISTING.
  - 060 EXISTING GLAZED WALL TILE TO REMAIN. PROTECT DURING CONSTRUCTION.
  - 061 TUCKPOINT AND REPAIR EXISTING CHIMNEY TO MATCH EXISTING MATERIALS. SEE EXTERIOR MASONRY REPORT AND DRAWINGS.
  - 062 EXISTING WOOD SINGLE HUNG WINDOW FRAME, SASH AND ALL CASING/TRIM TO REMAIN. PREPARE EXISTING INTERIOR & EXTERIOR SURFACES FOR NEW PAINT. REPLACE MISSING AND/OR BROKEN GLASS TO MATCH EXISTING AND INSTALL NEW GLAZING PUTTY AT ALL PANEALS. INSTALL NEW INTERIOR STORM WINDOWS. SEE DETAIL 13A510W.
  - 063 ALIGN EDGE OF DEMISING WALL WITH EDGE OF HISTORIC MASONRY OPENING.
  - 064 ALIGN CENTER OF DEMISING WALL OR PARTITION WITH CENTERLINE OF HISTORIC COLUMN, OR BEAM ABOVE.
  - 065 ALIGN EDGE OF DEMISING WALL WITH EDGE OF HISTORIC CONCRETE DROP SLAB.
  - 066 ALIGN CENTER OF DEMISING WALL PARTITION WITH CENTERLINE OF WINDOW MULLION.
  - 067 ALIGN EDGE OF DEMISING WALL WITH OUTER EDGE OF LIGHT MONITOR COLUMN.
  - 068 ALIGN CENTER OF DEMISING WALL OR PARTITION WITH CENTER OF HISTORIC SKYLIGHT MULLION ABOVE.
  - 069 NEW 3X3 ACCESS DOOR W/ 3-HR RATING @ WALL TO ABANDONED MECHANICAL TUNNEL.
  - 070 NEW CONCRETE SLAB AT EXISTING STOOP TO MATCH FLOOR HEIGHT AT BUILDING 7. SEE STRUCTURAL.
  - 071 EXISTING WOOD STAIR, GUARD AND HANDRAILS TO REMAIN. PREP ALL SURFACES FOR NEW PAINT.
  - 072 EXISTING WOOD STAIR, GUARD AND HANDRAILS TO REMAIN. REPAIR/REPLACE MISSING BEAD BOARD HANDRAIL SUPPORT AND STAIR RUN FROM LEVEL 01 TO 1ST LANDING TO MATCH EXISTING HISTORIC CONDITION PERCENT. PROVIDE NEW STEEL HANDRAILS AT EXISTING CMU WALLS. PREP ALL SURFACES FOR NEW PAINT.
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  - 075 NEW CHAINLINK FENCE & GATES/PRIVACY SLATS.
  - 076 BUILD TYPE P6 UNIT DEMISING WALL WITH RESILIENT CHANNEL ON THIS SIDE.
  - 077 TAPER GYPCRETE TOPPING 1:20 SLOPE MAX TO MEET EXISTING FINISH LEVEL AT TRANSITION AREA TO STAIRS OR BETWEEN BUILDINGS.
  - 078 NEW TAPERED POLISHED EPOXY FLOOR TOPPING TO TRANSITION FLOOR FINISH LEVEL CHANGE BETWEEN BUILDINGS 6 & 7. TAPER 1:20 SLOPE MAX.
  - 079 PATCH AND REPAIR DAMAGED AND MISSING EXTERIOR STUCCO TO MATCH ADJACENT SURFACE.

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  - DO NOT SCALE DRAWINGS. CONTRACTOR TO VERIFY ALL CONDITIONS AND DIMENSIONS AT THE JOB SITE PRIOR TO COMMENCING CONSTRUCTION.
  - FLOOR ELEVATIONS ARE TO THE TOP OF THE SUB-FLOOR MATERIAL UNLESS OTHERWISE NOTED.
  - CONTRACTORS SHALL JOINTLY PROVIDE AND INSTALL ALL STIFFENERS, BRACING, BANDING PLATES, WALL BLOCKING AND SUPPORTING BRACKETS REQUIRED FOR THE INSTALLATION OF CASEWORK, TOILET ACCESSORIES, PARTITIONS, MILLWORK, AND ALL WORK MOUNTED OR SUSPENDED BY ALL TRADES.

**NEW WORK PLAN LEGEND**

	EXISTING, TO REMAIN		MASONRY PARTITION, SEE PARTITION TYPES FOR DETAILS
	METAL STUD PARTITION, SEE PARTITION TYPES FOR DETAILS TYPE		CONCRETE FLOOR OPENING INFILL, SEE STRUCTURAL FOR INFILL CONDITIONS. V.I.F. EXACT SIZE AND LOCATIONS.
	CONCRETE FLOOR COSMETIC PATCH, V.I.F. EXACT SIZE AND LOCATIONS.		WOOD FLOOR STRUCTURAL INFILL, SEE STRUCTURAL FOR INFILL CONDITIONS. V.I.F. EXACT SIZE AND LOCATIONS.

**PATCH AND INFILL LEGEND**

	CONCRETE FLOOR OPENING INFILL, SEE STRUCTURAL FOR INFILL CONDITIONS. V.I.F. EXACT SIZE AND LOCATIONS.
	CONCRETE FLOOR COSMETIC PATCH, V.I.F. EXACT SIZE AND LOCATIONS.
	WOOD FLOOR STRUCTURAL INFILL, SEE STRUCTURAL FOR INFILL CONDITIONS. V.I.F. EXACT SIZE AND LOCATIONS.

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MILWAUKEE, WI 53210


SHEET TITLE  
NEW WORK PLAN - LEVEL 03 - BUILDINGS 8A & 8B

REVISIONS


1	10/09/20	ADDENDUM #1
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SCALE	VARES
PROJECT NUMBER	200102
SET TYPE	CONSTRUCTION DOCUMENTS
DATE ISSUED	9/25/20
SHEET NUMBER	A231W

1 NEW WORK PLAN - LEVEL 03 - BUILDING 8A  
Scale: 1/8" = 1'-0"

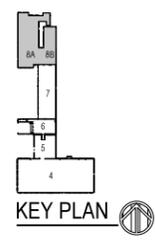

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**2 NEW WORK PLAN - ROOF - BUILDINGS 6, 7 & 8**

Scale: 1/16" = 1'-0"

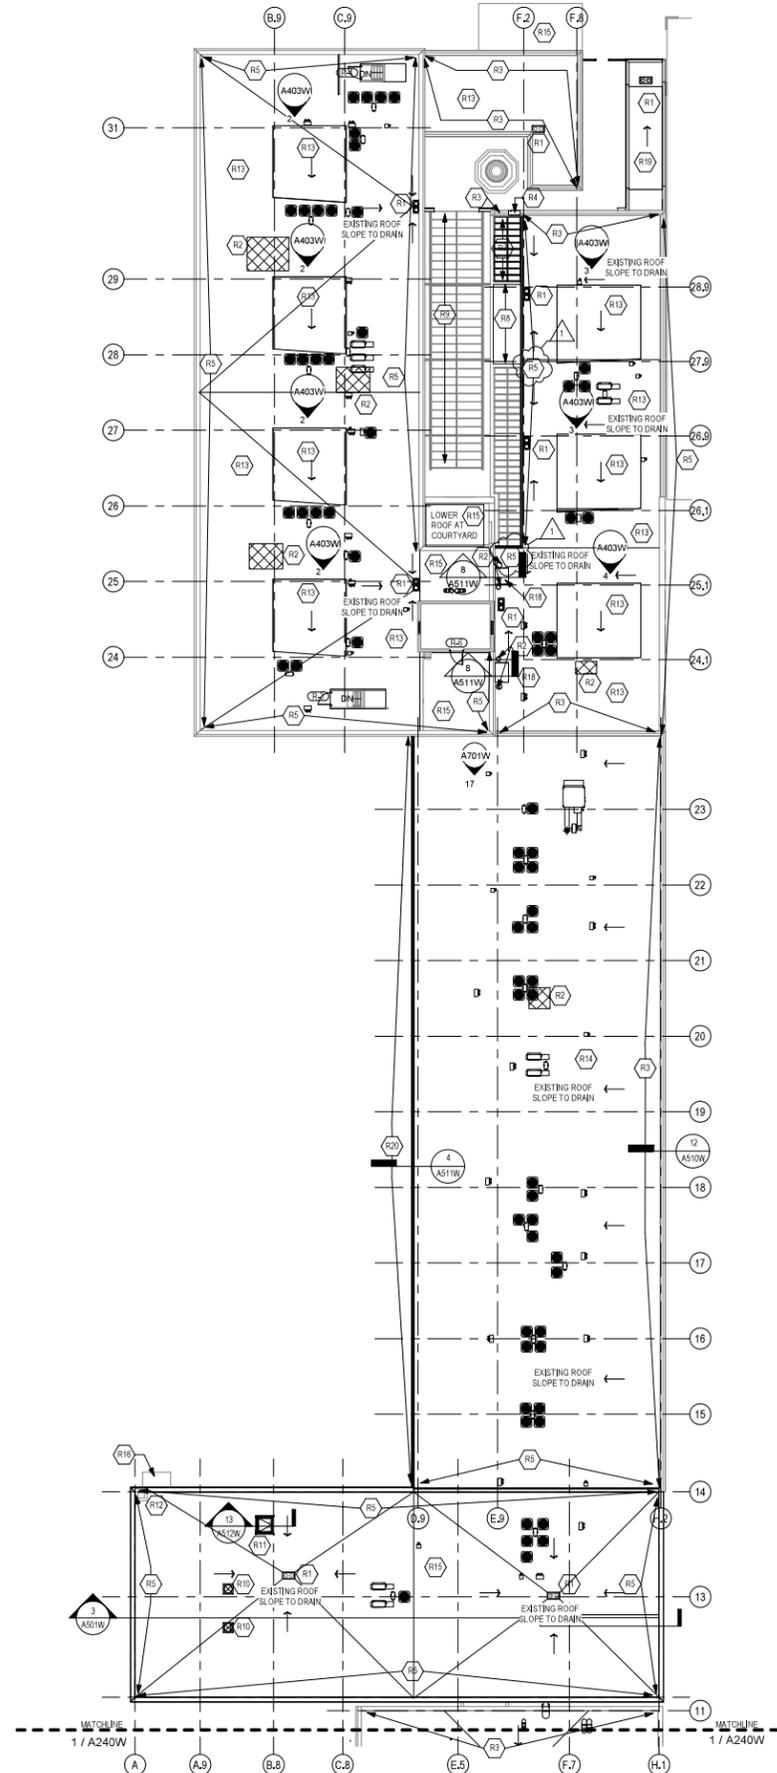

**GENERAL ROOF PLAN NOTES TO CONTRACTOR**


1. ROOFING CONTRACTOR TO PROVIDE FLASHINGS AND CROCKETS AT ALL EXTERIOR EQUIPMENT PENETRATIONS AND SUPPORT POSTS, ETC. REFER TO MECHANICAL DRAWINGS FOR DETAILS AND EXTENTS.
2. ROOFING CONTRACTOR TO PROVIDE MAINTENANCE WALK-OFF PADS AT ALL EXTERIOR EQUIPMENT LOCATIONS. REFER TO MECHANICAL DRAWINGS FOR EXTENTS.
3. THE GENERAL CONTRACTOR IS TO CALL A MEETING BETWEEN THE ROOFING CONTRACTOR AND PLUMBING CONTRACTOR TO COORDINATE THE FINAL DRAIN LOCATIONS. TAPERED INSULATION INSTALLED CONTRARY TO THE LOW POINT OF THE DRAIN, OVERFLOW, OR SCUPPER LOCATIONS SHALL BE CAUSE FOR REJECTION OF WORK.

**NEW WORK ROOF PLAN LEGEND**




**NEW WORK ROOF PLAN KEY NOTES**

- SEE PROJECT GENERAL CONDITIONS, GENERAL INFORMATION ON SHEET A001 AND SELECTIVE DEMOLITION, CUTTING AND PATCHING SPECIFICATIONS THAT ARE USED IN ASSOCIATION WITH THESE NOTES.
- NEW WORK ROOF PLAN KEY NOTES APPLY TO ALL NEW WORK ROOF PLAN DRAWINGS AND MAY NOT BE USED ON EVERY SHEET.
- R1 NEW ROOF DRAIN, CONDUCTOR AND OVERFLOW. LOCATE AT REMOVED ROOF DRAIN LOCATION. COORDINATE WITH PLUMBING.
  - R2 PATCH ROOF DECK AT DEMOLISHED ROOF EQUIPMENT.
  - R3 EXISTING CLAY TILE COPING TO REMAIN. SEAL ALL CRACKED COPINGS UNITS. RESET ALL EXISTING LOOSE COPING UNITS. IF MISSING OR DAMAGED BEYOND REPAIR, REPLACE IN KIND EXISTING CLAY TILE COPING TO REMAIN. SEAL ALL CRACKED COPINGS UNITS. RESET ALL EXISTING LOOSE COPING UNITS. REPAIR OR REPLACE COPING MISSING OR DAMAGED BEYOND REPAIR TO MATCH EXISTING.
  - R4 REPAIR MASONRY TO MATCH EXISTING AT MISSING CLAY TILE PARAPET CAP. PROVIDE NEW METAL PARAPET CAP THAT SIMULATES THE ADJACENT EXISTING CLAY TILE PARAPET CAP.
  - R5 PROVIDE NEW METAL ROOF COPING.
  - R6 HISTORIC STONE/PRECAST COPING TO REMAIN. SEAL ALL CRACKED COPINGS UNITS. RESET ALL EXISTING LOOSE COPING UNITS. IF MISSING OR DAMAGED BEYOND REPAIR, REPLACE IN KIND EXISTING CLAY TILE COPING TO REMAIN. SEAL ALL CRACKED COPINGS UNITS. RESET ALL EXISTING LOOSE COPING UNITS. REPLACE COPING MISSING OR DAMAGED BEYOND REPAIR WITH NEW COPING TO MATCH EXISTING.
  - R7 NEW SKYLIGHT SYSTEM TO REPLACE EXISTING DEMOLISHED SYSTEM. REPLICATE HISTORIC PROFILES AND DIMENSIONS.
  - R8 NEW LIGHT MONITOR/SKYLIGHT ROOF STRUCTURE. SEE STRUCTURAL.
  - R9 EXISTING SKYLIGHT AND STEEL STRUCTURE. SEE STRUCTURAL FOR NEW WORK NOTES. SCRAPE AND PAINT EXISTING STEEL SKYLIGHT SKELETON AND SUPPORT STRUCTURE.
  - R10 NEW TRASH CHUTE VENT THRU ROOF.
  - R11 NEW ROOF HATCH AT EXISTING LOCATION.
  - R12 EXISTING CHIMNEY TO REMAIN.
  - R13 NEW ROOF MEMBRANE, R-30 MIN. RIGID INSULATION AND VAPOR BARRIER. VERIFY CONDITION OF EXISTING WOOD DECKING BELOW PRIOR TO INSTALLATION OF NEW ROOF ASSEMBLY. REPLACE ROTTEN OR DAMAGED WOOD DECKING PLANKS TO MATCH MATERIAL TYPE AND DIRECTION OF EXISTING DECKING. COORDINATE WITH STRUCTURAL DRAWINGS FOR ADDITIONAL INFORMATION ON AREAS OF EXISTING ROOF DECK THAT NEED REPAIR.
  - R14 NEW ROOF MEMBRANE, R-30 MIN. RIGID INSULATION, VAPOR BARRIER, 5/8" EXTERIOR GYPSUM SHEATHING AND 3" METAL ROOF DECK INSTALLED OVER EXISTING PRECAST CONCRETE ROOF DECK. COORDINATE WITH STRUCTURAL DRAWINGS FOR ADDITIONAL INFORMATION ON AREAS OF EXISTING ROOF DECK THAT NEED REPAIR.
  - R15 NEW ROOF MEMBRANE, R-30 MIN. RIGID INSULATION AND VAPOR BARRIER INSTALLED ON EXISTING CONCRETE ROOF DECK.
  - R16 NEW ROOF MEMBRANE AND VAPOR BARRIER ON EXISTING CANOPY ROOF DECKING. PROVIDE NEW PREFINISHED METAL ROOF EDGE.
  - R17 NEW ROOF MEMBRANE AND VAPOR BARRIER INSTALLED ON EXISTING CONCRETE ROOF DECK.
  - R18 NEW CLRB, ROOF DECK, VAPOR BARRIER AND R-30 MIN. RIGID INSULATION AT EXISTING SKYLIGHT OPENING.
  - R19 NEW ROOF MEMBRANE, R-30 MIN. RIGID INSULATION, VAPOR BARRIER, 5/8" EXTERIOR GYPSUM SHEATHING AND METAL ROOF DECK. SEE STRUCTURAL DRAWINGS.
  - R20 NEW OUTER ENTIRE LENGTH OF ROOF. PROVIDE NEW DOWNSPOUTS. COORDINATE WITH PLUMBING.
  - R21 NEW METAL ROOF EDGE & GUTTER SYSTEM. COORDINATE WITH PLUMBING.

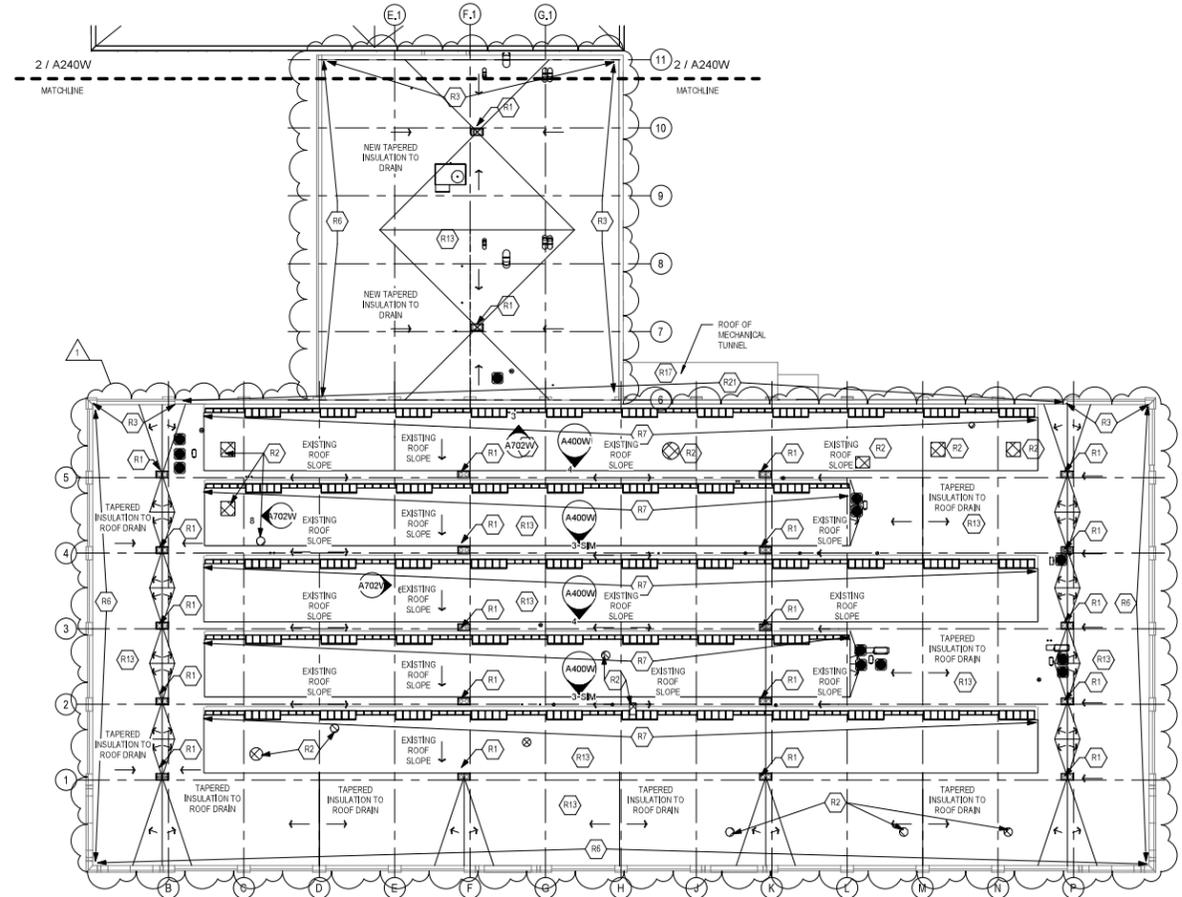

**1 NEW WORK PLAN - ROOF - BUILDINGS 4 & 5**

Scale: 1/16" = 1'-0"

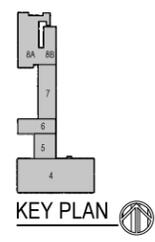

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MILWAUKEE, WI 53210

SHEET TITLE  
**NEW WORK PLAN - ROOF**

REVISIONS

1	10/09/20	ADDENDUM #1
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SCALE	VARIABLES
PROJECT NUMBER	200102
SET TYPE	CONSTRUCTION DOCUMENTS
DATE ISSUED	9/25/20
SHEET NUMBER	<b>A240W</b>

ATTACHMENT C

PE Certification

**VAPOR MITIGATION SYSTEM COMMISSIONING – NR 712.09 CERTIFICATIONS  
REVISED ADDITIONAL VAPOR SYSTEM COMMISSIONING PLAN FOR  
COMMUNITY WITHIN THE CORRIDOR – WEST BLOCK  
3212 W. Center St., 2727 N. 32nd St., and 2758 N. 33rd St., MILWAUKEE, WI 53210  
BRRTS #: 02-41-587376, FID #: 341333190  
April 14, 2023**

This report was prepared by: Robert T. Reineke, P.E.  
Senior Engineer

P.E. # 32737 – 006  
Date: April 14, 2023

"I, Robert T. Reineke, hereby certify that I am a registered professional engineer in the State of Wisconsin, registered in accordance with the requirements of ch. A-E 4, Wis. Adm. Code; that this document has been prepared in accordance with the Rules of Professional Conduct in ch. A-E 8, Wis. Adm. Code; and that, to the best of my knowledge, all information contained in this document is correct and the document was prepared in compliance with all applicable requirements in chs. NR 700 to 726, Wis. Adm. Code."

*Robert T. Reineke*

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